

# A (DEMOLITION / CONSTRUCTION PLAN) FOR: SUMTER COUNTY LIVESTOCK PAVILION (COW PALACE)

7620 STATE ROAD 471  
BUSHNELL, FLORIDA 33513

revisions

architect studio, inc.  
shapes the future

great design  
114 south magnolia avenue  
ocala, florida 34471  
www.rispollisa.com  
p: (352) 620-0596  
florida license ea0002485  
fso@rispollisa.com

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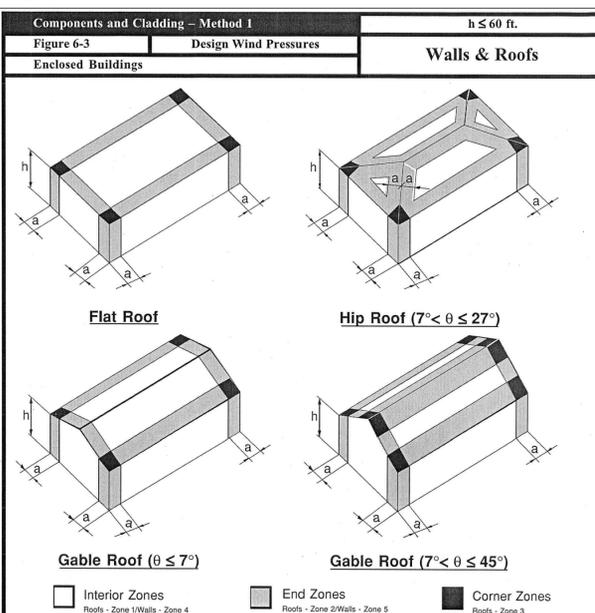
JOSEPH A. RISPOLI, ARCHITECT  
AIA, FL LICENSE: AR66489

CODE REFERENCE	BUILDING DATA:	INDEX OF DRAWINGS		
<p><u>APPLICABLE CODES:</u></p> <p>FLORIDA BUILDING CODE 2010 (EXISTING BUILDING, BUILDING, FUEL GAS, MECHANICAL &amp; PLUMBING VOLUMES) NATIONAL ELECTRIC CODE 2008 ED FFPC 2010 ED ASCE 7-2010 ED.</p>	<p>THESE DOCUMENTS ARE FOR THE DEMOLITION OF THE SUMTER COUNTY LIVESTOCK PAVILION (COW PALACE) 1 STORY CONCRETE AND METAL BUILDING. WORK TO INCLUDE LEAVING EXISTING SLAB IN PLACE WITH CONCRETE FLOOR FILL-IN'S AND NEW MODIFIED ELECTRICAL SERVICES, AND COW PIG BARN GABLE END RE-CONSTRUCTION.</p>	<p><u>GC - GENERAL CONDITIONS</u></p> <p>A000 COVER, PROJECT INFORMATION</p> <p><u>C - CIVIL PLANS</u></p> <p>1 OF 2 COVER SHEET 2 OF 2 SITE PLAN</p> <p><u>D100 - DEMOLITION PLANS</u></p> <p>D100 DEMOLITION FLOOR PLAN D101 DEMOLITION ELEVATIONS</p> <p><u>A100 - FOUNDATION PLANS</u></p> <p>A101 FOUNDATION PLAN, DETAILS AND SCHEDULE</p> <p><u>A200 - ARCHITECTURAL: PLANS</u></p> <p>A201N FLOOR PLAN - NOTES AND TAGS</p> <p><u>A300 - EXTERIOR ELEVATIONS</u></p> <p>A301 PROPOSED EXTERIOR ELEVATIONS</p> <p><u>A500 - SECTIONS &amp; DETAILS</u></p> <p>A501 WALL SECTIONS A502 DETAILS A503 DETAILS</p> <p><u>E - ELECTRICAL</u></p> <p>E100 MECHANICAL, PLUMBING &amp; ELECTRICAL DEMOLITION / NEW PLAN</p>		
	<p><b>ENGINEERS</b></p> <table border="1"> <tr> <td> <p><u>MECHANICAL, ELECTRICAL, PLUMBING:</u></p> <p>INGENUITY ENGINEERING 4798 NEW BROAD STREET, SUITE 300 ORLANDO, FL 32814 (407) 398-6007 DGREEN@INGENUITYEI.COM</p> </td> <td> <p><u>CIVIL:</u></p> <p>GRIFFEY ENGINEERING 406 N. CENTER STREET EUSTIS, FL 32726 (352) 357-3528 DAG@GRIFFEYENGINEERING.COM</p> </td> </tr> </table>	<p><u>MECHANICAL, ELECTRICAL, PLUMBING:</u></p> <p>INGENUITY ENGINEERING 4798 NEW BROAD STREET, SUITE 300 ORLANDO, FL 32814 (407) 398-6007 DGREEN@INGENUITYEI.COM</p>	<p><u>CIVIL:</u></p> <p>GRIFFEY ENGINEERING 406 N. CENTER STREET EUSTIS, FL 32726 (352) 357-3528 DAG@GRIFFEYENGINEERING.COM</p>	
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	<p><b>STRUCTURAL DESIGN DATA:</b></p> <p><b>WIND DESIGN DATA:</b></p> <p>BASIC WINDSPEED: (140) MPH (FBC FIGURE 1609C) WIND IMPORTANCE FACTOR: (IV) (RISK CATEGORY FBC TABLE 1604.5) WIND EXPOSURE: (B) (FBC 1609.4.3) APPLICABLE INTERNAL PRESSURE COEFFICIENT: 0.18 FOR ENCLOSED STRUCTURES AND 0.55 FOR COVERED ENTRIES / OPEN STRUCTURES A = 3' (MIN. USING 40% OF EAVE HT.) OR MIN. 10% OF LEAST HORIZONTAL DIM. WHICH EVER IS SMALLER (SEE FIGURE 6-3 FROM ASCE 7 BELOW)</p> <p>COMPONENT &amp; CLADDING DESIGN PRESSURE LOADS: SUPPLIERS / MANUFACTURERS OF ALL CLADDING AND COMPONENTS (INCLUDING, BUT NOT LIMITED TO: SIDING, ROOFING, DOORS, WINDOWS, AWNINGS, ETC.) WILL SUBMIT REPORTS &amp; DATA SIGNED AND SEALED BY A LICENSED STRUCTURAL ENGINEER IN THE STATE OF FLORIDA DOCUMENTING COMPLIANCE WITH THIS PROVISION OF THE FLORIDA BUILDING CODE 2010 EDITION.</p>			

FROM ASCE 7

Components and Cladding - Method 1		h ≤ 60 ft.												
Figure 6-3 (cont'd)	Net Design Wind Pressures	Walls & Roofs												
Enclosed Buildings														
Net Design Wind Pressure, p <sub>wind</sub> (psf) (Exposure B at h = 30 ft. with I = 1.0 and K <sub>zt</sub> = 1.0)														
	Zone	Basic Wind Speed V (mph)												
	Effective wind area (sq ft)	125	130											
		140	150											
		145	170											
Roof 0 to 7 degrees	1	10	11.4	-28.1	12.4	-30.4	14.3	-35.3	15.4	-37.8	16.5	-40.5	21.1	-52.0
	1	20	10.7	-27.4	11.6	-29.6	13.4	-34.4	14.4	-36.9	15.4	-39.4	19.8	-50.7
	1	50	9.8	-26.4	10.6	-28.6	12.3	-33.2	13.1	-35.6	14.1	-38.1	18.1	-48.9
	1	100	9.1	-25.7	9.8	-27.8	11.4	-32.3	12.2	-34.6	13.0	-37.0	16.7	-47.6
	2	10	11.4	-47.2	12.4	-51.0	14.3	-59.2	15.4	-63.5	16.5	-67.9	21.1	-87.2
	2	20	10.7	-42.1	11.6	-45.6	13.4	-52.9	14.4	-56.7	15.4	-60.7	19.8	-78.0
	2	50	9.8	-35.5	10.6	-38.4	12.3	-44.5	13.1	-47.8	14.1	-51.1	18.1	-65.7
	2	100	9.1	-30.5	9.8	-33.0	11.4	-38.2	12.2	-41.0	13.0	-43.9	16.7	-56.4
	3	10	11.4	-71.0	12.4	-76.8	14.3	-89.0	15.4	-95.5	16.5	-102.2	21.1	-131.3
	3	20	10.7	-58.5	11.6	-63.6	13.4	-73.8	14.4	-79.1	15.4	-84.7	19.8	-108.7
	3	50	9.8	-42.7	10.6	-46.2	12.3	-53.5	13.1	-57.4	14.1	-61.5	18.1	-78.9
	3	100	9.1	-30.5	9.8	-33.0	11.4	-38.2	12.2	-41.0	13.0	-43.9	16.7	-56.4
Roof > 7 to 27 degrees	1	10	16.2	-25.7	17.5	-27.8	20.3	-32.3	21.8	-34.6	23.3	-37.0	30.0	-47.6
	1	20	14.8	-25.0	16.0	-27.0	18.5	-31.4	19.9	-33.7	21.3	-36.0	27.3	-46.3
	1	50	12.9	-24.1	13.9	-26.0	16.1	-30.2	17.3	-32.4	18.5	-34.6	23.8	-44.5
	1	100	11.4	-23.2	12.4	-25.2	14.3	-29.3	15.4	-31.4	16.5	-33.6	21.1	-43.2
	2	10	16.2	-44.8	17.5	-48.4	20.3	-56.2	21.8	-60.3	23.3	-64.5	30.0	-82.8
	2	20	14.8	-41.2	16.0	-44.6	18.5	-51.7	19.9	-54.4	21.3	-59.3	27.3	-76.2
	2	50	12.9	-36.5	13.9	-39.4	16.1	-45.7	17.3	-49.1	18.5	-52.5	23.8	-67.4
	2	100	11.4	-32.9	12.4	-35.6	14.3	-41.2	15.4	-44.2	16.5	-47.3	21.1	-60.8
	3	10	16.2	-66.2	17.5	-71.6	20.3	-83.1	21.8	-89.1	23.3	-95.4	30.0	-122.5
	3	20	14.8	-61.9	16.0	-67.0	18.5	-77.7	19.9	-83.3	21.3	-89.2	27.3	-114.5
	3	50	12.9	-56.2	13.9	-60.8	16.1	-70.5	17.3	-75.7	18.5	-81.0	23.8	-104.0
	3	100	11.4	-51.9	12.4	-56.2	14.3	-65.1	15.4	-69.9	16.5	-74.8	21.1	-96.0
Roof > 27 to 45 degrees	1	10	25.7	-28.1	27.8	-30.4	32.3	-35.3	34.6	-37.8	37.0	-40.5	47.6	-52.0
	1	20	25.0	-26.7	27.0	-28.9	31.4	-33.5	33.7	-35.9	36.0	-38.4	46.3	-49.3
	1	50	24.1	-24.8	26.0	-26.8	30.2	-31.1	32.4	-33.3	34.6	-35.7	44.5	-45.8
	1	100	23.3	-23.3	25.2	-25.2	29.3	-29.3	31.4	-31.4	33.6	-33.6	43.2	-43.2
	2	10	25.7	-32.9	27.8	-35.6	32.3	-41.2	34.6	-44.2	37.0	-47.3	47.6	-60.8
	2	20	25.0	-31.4	27.0	-34.0	31.4	-39.4	33.7	-42.3	36.0	-45.3	46.3	-58.1
	2	50	24.1	-29.5	26.0	-32.0	30.2	-37.1	32.4	-39.8	34.6	-42.5	44.5	-54.6
	2	100	23.2	-28.1	25.2	-30.4	29.3	-35.3	31.4	-37.8	33.6	-40.5	43.2	-52.0
	3	10	25.7	-32.9	27.8	-35.6	32.3	-41.2	34.6	-44.2	37.0	-47.3	47.6	-60.8
	3	20	25.0	-31.4	27.0	-34.0	31.4	-39.4	33.7	-42.3	36.0	-45.3	46.3	-58.1
	3	50	24.1	-29.5	26.0	-32.0	30.2	-37.1	32.4	-39.8	34.6	-42.5	44.5	-54.6
	3	100	23.3	-28.1	25.2	-30.4	29.3	-35.3	31.4	-37.8	33.6	-40.5	43.2	-52.0
Wall	4	10	28.1	-30.5	30.4	-33.0	35.3	-38.2	37.8	-41.0	40.5	-43.9	52.0	-56.4
	4	20	26.8	-29.2	29.0	-31.6	33.7	-36.7	36.1	-39.3	38.7	-42.1	49.6	-54.1
	4	50	25.2	-27.5	27.2	-29.8	31.6	-34.6	33.9	-37.1	36.2	-39.7	46.6	-51.0
	4	100	23.9	-26.3	25.9	-28.4	30.0	-33.0	32.2	-35.4	34.4	-37.8	44.2	-48.6
	4	500	21.0	-23.3	22.7	-25.2	26.3	-29.3	28.2	-31.4	30.2	-33.6	38.8	-43.2
	5	10	28.1	-37.6	30.4	-40.7	35.3	-47.2	37.8	-50.6	40.5	-54.2	52.0	-69.6
	5	20	26.8	-35.1	29.0	-38.0	33.7	-44.0	36.1	-47.2	38.7	-50.5	49.6	-64.9
	5	50	25.2	-31.8	27.2	-34.3	31.6	-39.8	33.9	-42.7	36.2	-45.7	46.6	-58.7
	5	100	23.9	-29.2	25.9	-31.6	30.0	-36.7	32.2	-39.3	34.4	-42.1	44.2	-54.1
	5	500	21.0	-23.2	22.7	-25.2	26.3	-29.3	28.2	-31.1	30.2	-33.6	38.8	-43.2

Unit Conversions - 1.0 ft = 0.3048 m; 1.0 psf = 0.0479 kN/m<sup>2</sup>



Notes:

- Pressures shown are applied normal to the surface, for exposure B, at h = 30 ft (9.1m), I = 1.0, and K<sub>zt</sub> = 1.0. Adjust to other conditions using Equation 6-2.
- Plus and minus signs signify pressures acting toward and away from the surfaces, respectively.
- For hip roofs with θ <= 27°, Zone 3 shall be treated as Zone 2.
- For effective wind areas between those given, value may be interpolated, otherwise use the value associated with the lower effective wind area.
- Notation:  
a: 10 percent of least horizontal dimension or 0.4h, whichever is smaller, but not less than either 4% of least horizontal dimension or 3 ft (0.9 m).  
A: Mean roof height, in feet (meters), except that eave height shall be used for roof angles <10°.  
θ: Angle of plane of roof from horizontal, in degrees.

seal

A DEMOLITION / CONSTRUCTION PLAN FOR:

**SUMTER COUNTY LIVESTOCK ARENA (COW PALACE)**  
7620 STATE ROAD 471  
BUSHNELL, FLORIDA 33513

drawn ASI	project no. 1251
checked ASI	date 11-20-12
sheet no. A000	

100%  
CONSTRUCTION  
DRAWINGS

# SUMTER COUNTY LIVESTOCK ARENA (COW PALACE) SITE PLAN

## 100% CONSTRUCTION PLANS

### CLIENT

Scott B. Cotrell, PE  
Public Works Director  
Sumter County BCC  
319 East Anderson Avenue  
Bushnell, FL 33513  
Ph. 352.569.1532 Fax 352.793.0207

### ARCHITECT

Joe Rispoli  
Architecture Studio, Inc.  
114 South Magnolia Avenue  
Ocala, FL 34474  
Ph. 352.620.0944 Fax 352.620.0996

### CIVIL ENGINEER

Donald Griffey, PE  
Griffey Engineering, Inc.  
406 North Center Street  
Eustis, FL 32726  
Ph. 352.357.3528 Fax 352.357.3219


### INDEX

1. COVER SHEET
2. SITE PLAN

**MAINTENANCE STATEMENT:**  
Sumter County shall maintain the site infrastructure.

**CALL BEFORE YOU DIG:**


**Sunshine State One Call**  
11 Plantation Road  
DeBary, FL 32713  
Admin: (800) 638-4097  
Locates: 811 or (800) 432-4770

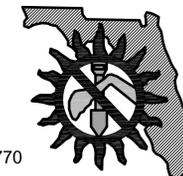

**VICINITY MAP**



**AERIAL MAP**

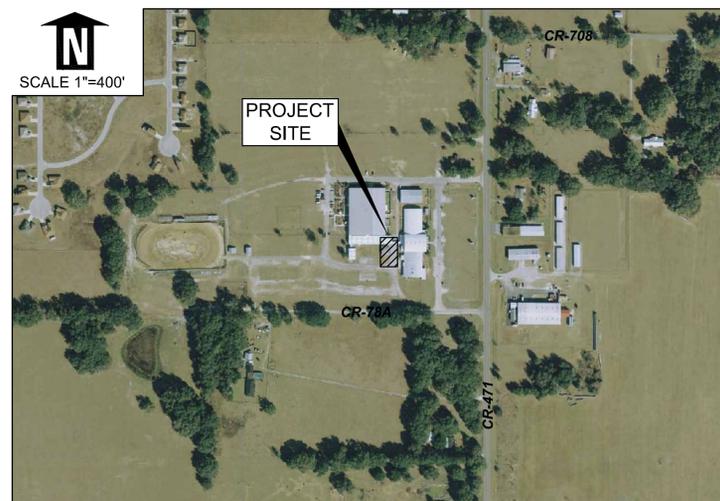

**PROPERTY DESCRIPTION**

S1/2 OF NE1/4 OF SE1/4 LESS BEG AT SW COR RUN N  
660 FT E 100 FT S 660 FT W 100FT TO BEG

DONALD A. GRIFFEY  
FLORIDA 039728  
GEORGIA 027524

GRIFFEY ENGINEERING  
406 N. CENTER STREET  
EUSTIS, FLORIDA 32726  
PHONE (352) 357-3528  
FAX (352) 357-3219  
FLORIDA CERT. OF AUTH. # 8062



BOARD OF COUNTY  
COMMISSIONERS  
SUMTER COUNTY, FLORIDA  
319 E. ANDERSON AVENUE  
BUSHNELL, FLORIDA 33513  
PHONE (352) 569-1532  
FAX (352) 793-0207

SUMTER COUNTY LIVESTOCK  
ARENA (COW PALACE)  
SITE PLAN  
100% CONSTRUCTION PLANS

COVER

REV. #	DATE	DRAWN BY:
		D.M.K.
		CHECKED BY:
		D.A.G.
	11-19-12	DRAWING #:
		12009 3.DWG
	11-16-12	PROJECT #:
		12009SPN
DATE:		SCALE:
	10-15-12	



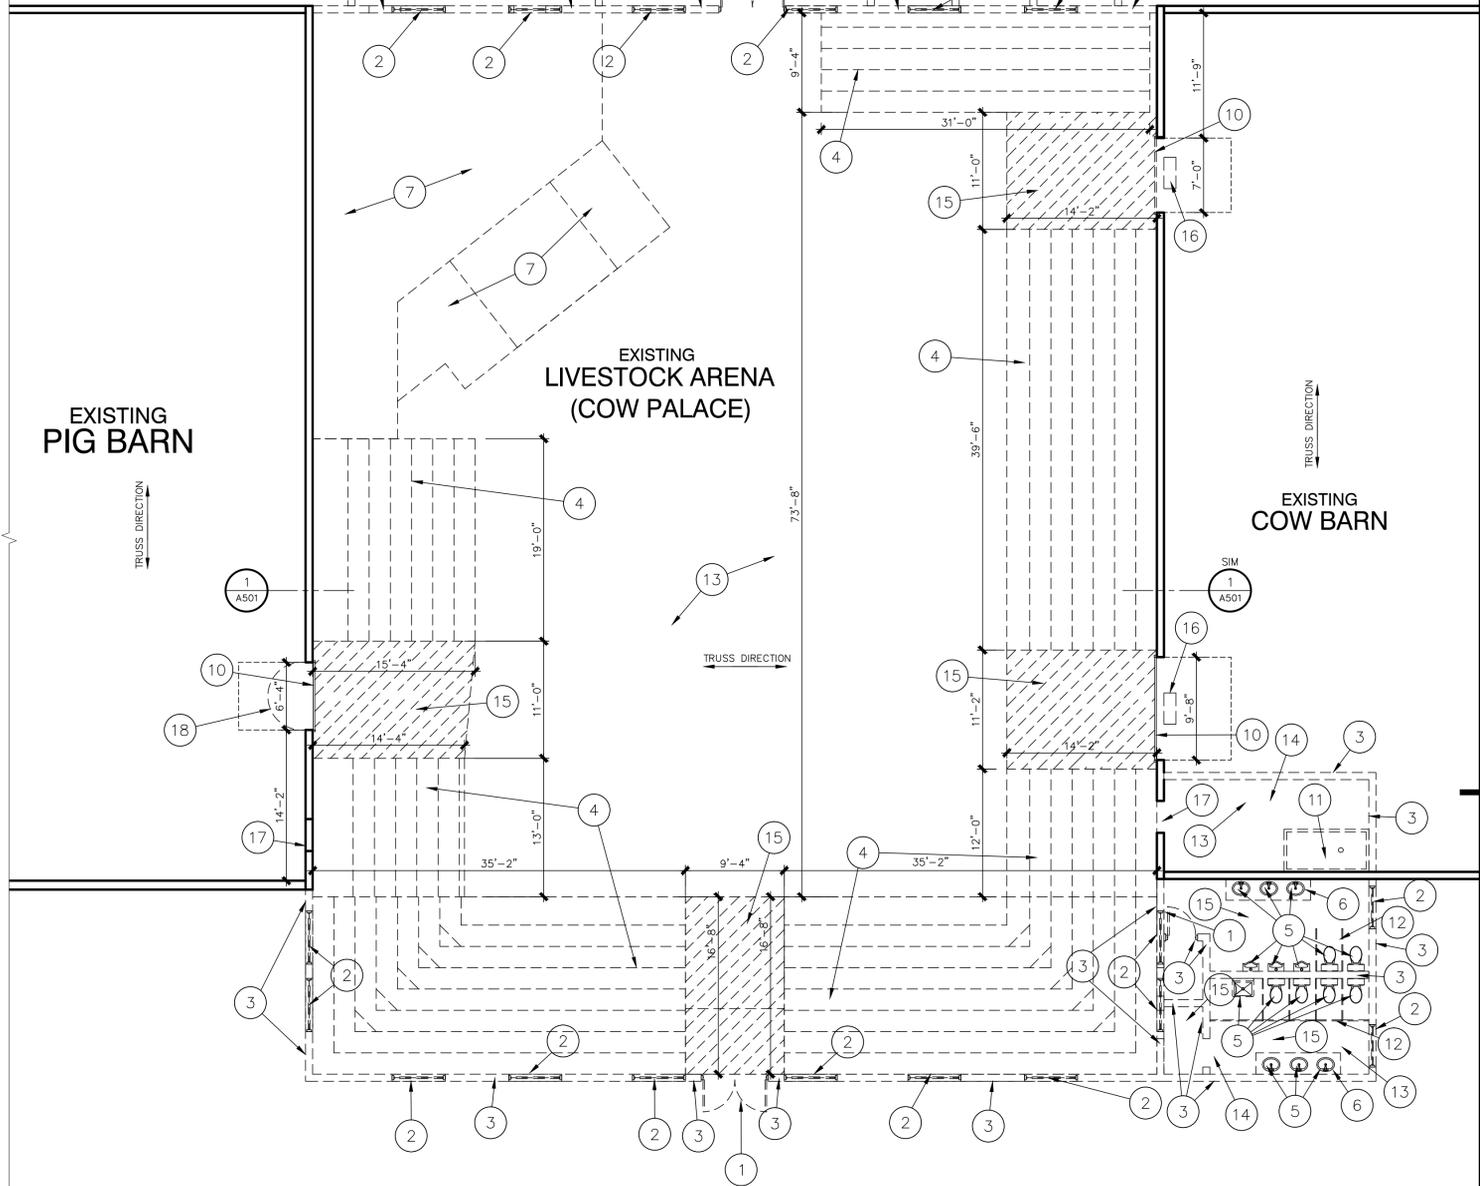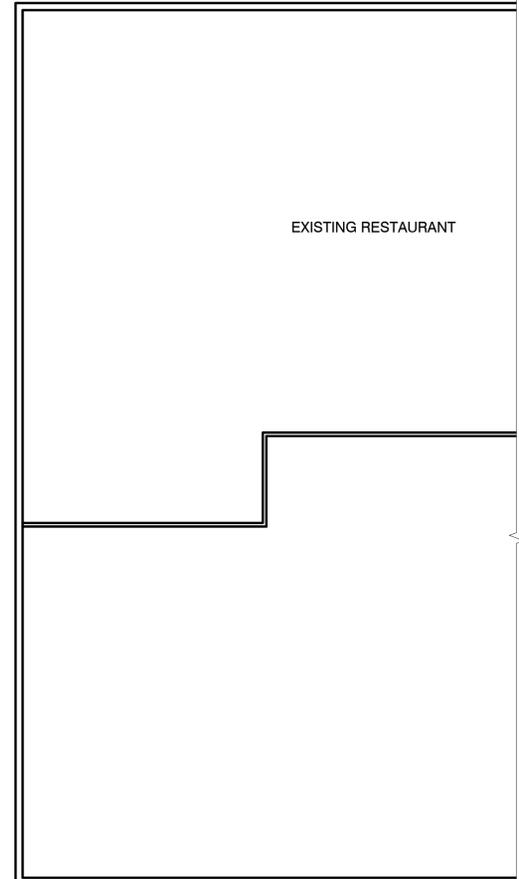

**DEMOLITION FLOOR PLAN**  
SCALE: 1/8" = 1'-0"

**GENERAL DEMOLITION NOTES**

1. CONTRACTOR SHALL COORDINATE CONSTRUCTION ACTIVITY W/ OWNER REGARDING HOURS OF OPERATION AS NOT TO DISRUPT DAILY BUSINESS ACTIVITY. PROVIDE SAFE OWNER ACCESS DURING CONSTRUCTION PERIOD AND LOCKABLE FRONT ENTRANCE W/ TENANT AND CONTRACTOR HAVING KEYED ACCESS.
2. USE V-SQUEEEN TO PROTECT PARTS OF THE EXISTING WORK SCHEDULED TO REMAIN. CUT AWAY CAREFULLY THE PARTS TO BE DEMOLISHED TO REDUCE THE AMOUNT OF NECESSARY REPAIRS.
3. PROVIDE TEMPORARY SHORING TO STRUCTURE AS NEEDED DURING CUTTING OF NEW OPENINGS.
4. PREVENT ACCUMULATION OF DEBRIS AND OVERLOADING OF ANY CONSTRUCTION MATERIALS TO THE STRUCTURE.
5. PREVENT DAMAGE TO OVERHEAD WIRES, UNDERGROUND CABLES, TELEPHONE, WATER AND SEWER LINES DURING DEMOLITION OPERATIONS.
6. AFTER COMPLETION OF THE DEMOLITION WORK, LEAVE SITE NEAT & ORDERLY ON A DAILY BASIS.
7. CONTRACTOR IS RESPONSIBLE FOR MEANS & METHODS INCLUDING ESTABLISHING AND MAINTAINING A SAFE OSHA COMPLIANT WORK ENVIRONMENT.
8. CONTRACTOR SHALL ARRANGE WITH THE UTILITY COMPANIES FOR THE DISCONNECTION OF SERVICES BEFORE STARTING DEMOLITION WORK AS REQUIRED.
9. PREVENT ACCESS OF UNAUTHORIZED PERSONS TO PARTLY DEMOLISHED STRUCTURES. PROVIDE BARRICADES OR RIBBONED OFF ZONES.
10. ITEMS FOR REUSE SHALL BE STORED BY CONTRACTOR ON SITE IN OWNER'S BUILDING AT SPECIFIED LOCATION. ITEMS TO BE RE-USED ARE TO BE CLEANED, PATCHED, REFINISHED, PAINTED OR REPAIRED AS REQUIRED PRIOR TO INSTALLATION.
11. ITEMS NOT TO BE RETAINED BY OWNER SHALL BE DISPOSED OF BY THE CONTRACTOR AT THE CONTRACTOR'S EXPENSE.
12. EXISTING ASPHALT, TREES, SPRINKLER HEADS, AND MISCELLANEOUS ITEMS THAT CONFLICT W/ PROPOSED CONSTRUCTION SHALL BE COORDINATED BY GENERAL CONTRACTOR FOR REMOVAL AND / OR RELOCATION PRIOR TO COMMENCEMENT OF WORK.
13. CONTRACTOR IS RESPONSIBLE FOR LEGALLY DISPOSING OF ALL MATERIALS AND ASSOCIATED COST OF INTERIM STORAGE FACILITIES (DUMPSTER).
14. PRIOR TO COMMENCEMENT OF DEMOLITION WORK CONTRACTOR SHALL INVESTIGATE EXISTING LOAD BEARING WALL CONDITIONS. IF LOAD BEARING WALLS ARE ENCOUNTERED AND NEED ALTERATIONS DUE TO NEW FLOOR PLAN LAYOUT, THE STRUCTURE SHALL BE SHORED, BRACED AND SUPPORTED AS NEEDED TO MAINTAIN STRUCTURAL INTEGRITY DURING STRUCTURE MODIFICATIONS.
15. AFTER SCHEDULED DEMOLITION OF WALLS, FLOORS, CEILING CONTRACTOR SHALL PATCH WALLS, FLOORS, ROOF W/ MATERIALS TO MATCH ADJACENT WALL, FLOOR, ROOF MATERIAL AS NEEDED FOR THE PROPER APPLICATION OF NEW FINISHES. PROVIDE FLUSH CONTINUOUS WALL, FLOOR, ROOF FINISHES.
16. POWER RECEPTACLES AND COMMUNICATION SYSTEM AND RELATED WIRING THAT CONFLICT W/ SCHEDULED CONSTRUCTION SHALL BE REMOVED.
17. H.V.A.C. GRILLES AND RELATED DUCTS AND HARDWARE THAT CONFLICT W/ SCHEDULED CONSTRUCTION SHALL BE REMOVED.
18. ACCESS TO PLUMBING LINES LOCATED ABOVE FLOOR AREAS SHALL BE COORDINATED WITH OWNER AS NEEDED. PLUMBING LINES SHALL BE CAPPED OR REMOVED AS REQUIRED FOR SCHEDULED CONSTRUCTION. ALL NEW FINISHES SHALL BE PATCHED AND REFINISHED AS NEEDED TO PROVIDE FLUSH, SMOOTH AND COMPATIBLE FINISHES TO ADJACENT AREAS.
19. REMOVE ALL CEILING ASSEMBLIES INCLUDING SUSPENSION SYSTEMS, HARDWARE, AND ALL RELATED ITEMS, AS REQ'D.
20. REMOVE EXISTING SUBSTRATES WHICH ARE DAMAGED OR NOT ACCEPTABLE FOR THE APPLICATION OF SCHEDULED NEW FINISHES.
21. FLOOR, WALL AND CEILING FINISHES THAT CONFLICT W/ THE APPLICATION OF SCHEDULED NEW FINISHES SHALL BE REMOVED AND SURFACE PREPARED AS NEEDED FOR THE PROPER APPLICATION OF NEW FINISHES. ADJACENT AREAS TO BE PROTECTED & WHERE DAMAGED, REPLACED.
22. EXISTING DEMOLITION MUST BE COMPLETE FROM FINISH FLOOR TO BOTTOM OF DECK & WHERE APPLICABLE, WALL TO WALL.
23. ALL EXISTING PIPING PENETRATIONS THRU CONCRETE SLAB MUST BE CAPPED A MINIMUM OF 3" BELOW SLAB. EXISTING CONCRETE SLABS AND EDGES MUST BE LEFT SMOOTH.
24. THE GENERAL CONTRACTOR MUST FIELD VERIFY ALL EXISTING ROOF DRAIN AND DOWNSPOUT DISCHARGE POINTS PRIOR TO CONSTRUCTION. MODIFY, REDIRECT, REPAIR & REPLACE AS REQUIRED FOR A COMPLETE AND PROPER OPERATIONAL STORM DRAIN SYSTEM.

**WALL TYPE LEGEND**

- EXISTING WALL TO REMAIN
- EXISTING WALL TO BE REMOVED
- DASHED LINES INDICATES ITEM TO BE REMOVED

**DEMOLITION SCHEDULE**

- 1 REMOVE EXISTING DOOR AND FRAME.
- 2 REMOVE EXISTING WINDOW, FRAME, SILL AND ALL ATTACHMENTS
- 3 REMOVE EXISTING WALL (OR PORTION AS INDICATED)
- 4 REMOVE EXISTING WOOD, METAL AND CONCRETE BLEACHERS REMOVE METAL BRACING SUPPORTS AND CONCRETE WALLS UNDER BLEACHERS AND ALL RELATED HARDWARE AND FRAMING ASSOCIATED.
- 5 REMOVE EXISTING PLUMBING FIXTURES
- 6 REMOVE EXISTING COUNTER
- 7 REMOVE EXISTING WOODEN STAGE AND CONCRETE STAGE AND ALL WALLS IN STAGE AREA
- 8 REMOVE EXISTING WOODEN RAMP AND CONCRETE STAIRS BELOW, ALSO WOODEN STAIRS
- 9 REMOVE EXISTING CONCRETE RAMP
- 10 REMOVE EXISTING OVERHEAD DOOR AND AND REPLACE ON OTHER SIDE OF WALL
- 11 REMOVE EXISTING ANIMAL WASHING AREA AND ALL ASSOCIATED PLUMBING PIPES AND ANY OTHER RELATED HARDWARE/MATERIALS.
- 12 REMOVE EXISTING TOILET PARTITION WALLS AND ALL RELATED HARDWARE AND ASSOCIATED MATERIALS
- 13 EXISTING CONCRETE FLOOR TO REMAIN AND REPAIRED
- 14 REMOVE EXISTING CEILING, WOOD MEMBERS AND ROOF MATERIAL
- 15 REMOVE EXISTING CONCRETE FLOOR
- 16 REMOVE EXISTING EXHAUST FANS AND RELOCATE AS PER OWNERS REQUEST.
- 17 EXISTING DOOR OPENING TO BE FILLED IN SEE PROPOSED PLAN
- 18 REMOVE ASPHALT BUILT-UP RAMP TO MAIN SLAB

**architecture studio, inc.**  
 great design shapes the future  
 114 south magnolia avenue  
 ocala, florida 34471  
 www.rfspolisosa.com  
 p: (352) 620-0944 f: (352) 620-0596  
 fsai@rfspolisosa.com  
 florida license aa002485

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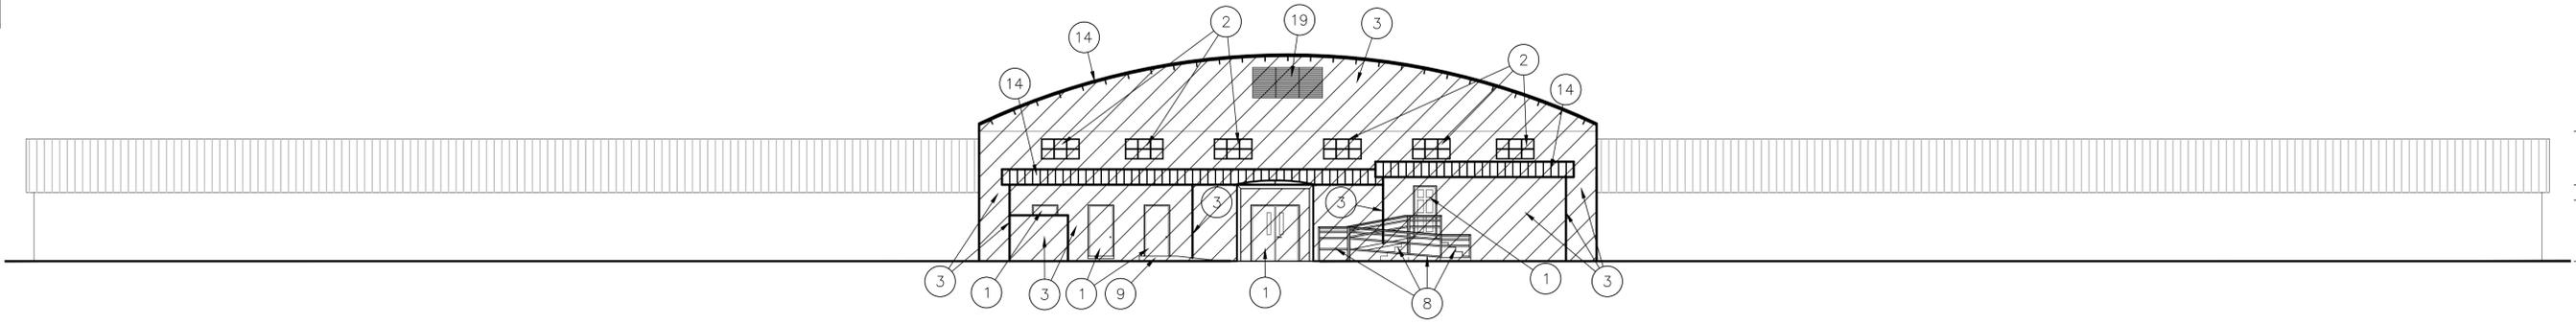
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 A DEMOLITION / CONSTRUCTION PLAN FOR:  
**SUMNER COUNTY LIVESTOCK ARENA (COW PALACE)**  
**7620 STATE ROAD 471**  
**BUSHNELL, FLORIDA 33513**

drawn AS I	project no. 1251
checked AS I	date 11-20-12

sheet no.  
**D100**




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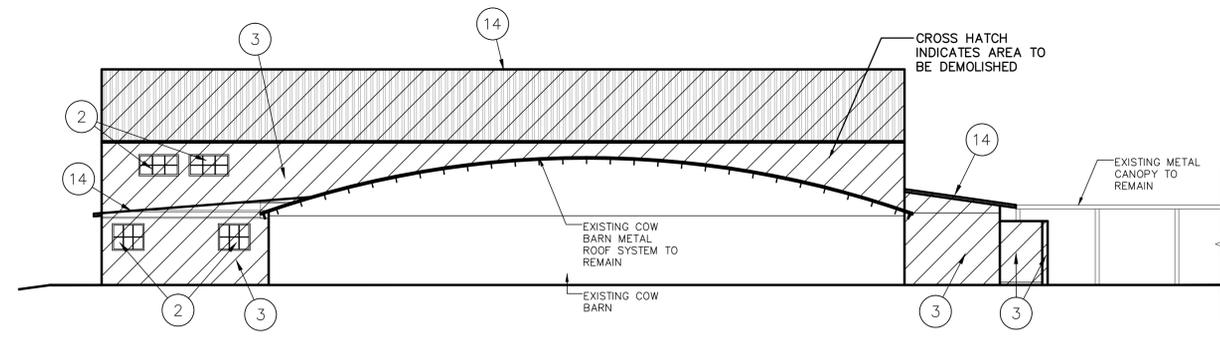
**EXISTING WEST ELEVATION (DEMOLITION)**

SCALE: 3/32" = 1'-0"




**EXISTING EAST ELEVATION (DEMOLITION)**

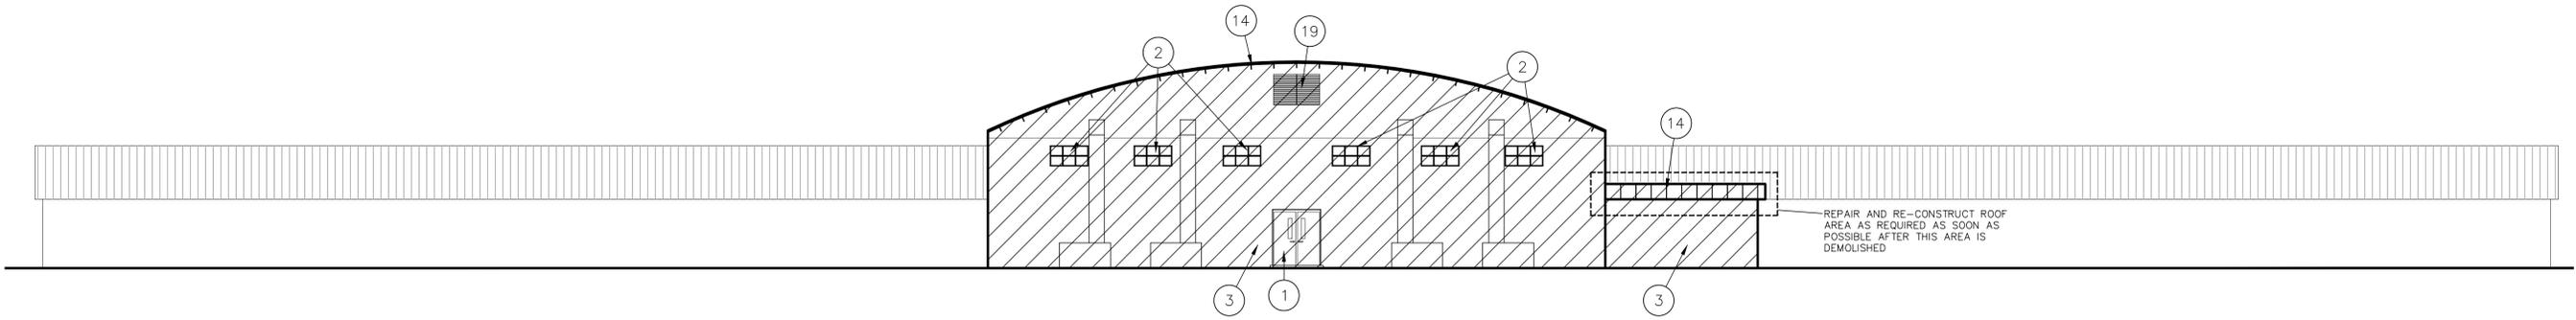SCALE: 3/32" = 1'-0"



**EXISTING NORTH ELEVATION (DEMOLITION)**

SCALE: 3/32" = 1'-0"

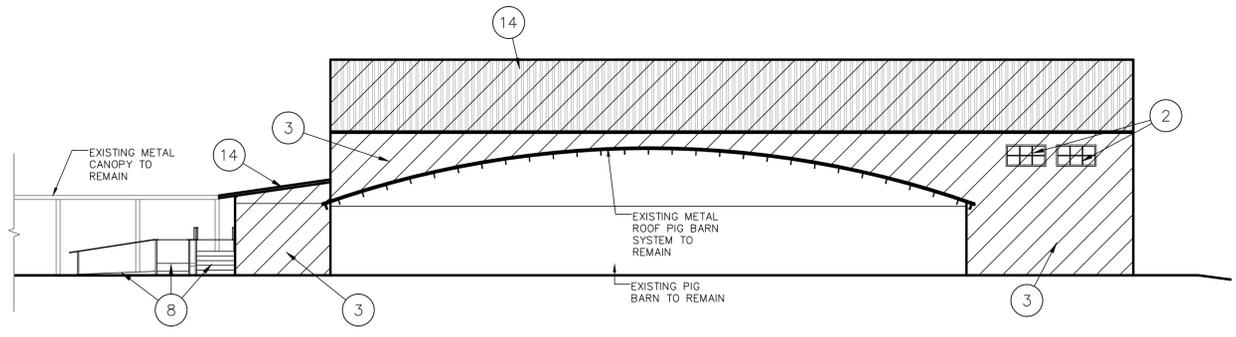

**EXISTING SOUTH ELEVATION (DEMOLITION)**

SCALE: 3/32" = 1'-0"

**GENERAL DEMOLITION NOTES**

1. CONTRACTOR SHALL COORDINATE CONSTRUCTION ACTIVITY W/ OWNER REGARDING HOURS OF OPERATION AS NOT TO DISRUPT DAILY BUSINESS ACTIVITY. PROVIDE SAFE OWNER ACCESS DURING CONSTRUCTION PERIOD AND LOCKABLE FRONT ENTRANCE W/ TENANT AND CONTRACTOR HAVING KEYED ACCESS.
2. USE VISQUEEN TO PROTECT PARTS OF THE EXISTING WORK SCHEDULED TO REMAIN. CUT AWAY CAREFULLY THE PARTS TO BE DEMOLISHED TO REDUCE THE AMOUNT OF NECESSARY REPAIRS.
3. PROVIDE TEMPORARY SHORING TO STRUCTURE AS NEEDED DURING CUTTING OF NEW OPENINGS.
4. PREVENT ACCUMULATION OF DEBRIS AND OVERLOADING OF ANY CONSTRUCTION MATERIALS TO THE STRUCTURE.
5. PREVENT DAMAGE TO OVERHEAD WIRES, UNDERGROUND CABLES, TELEPHONE, WATER AND SEWER LINES DURING DEMOLITION OPERATIONS.
6. AFTER COMPLETION OF THE DEMOLITION WORK, LEAVE SITE NEAT & ORDERLY ON A DAILY BASIS.
7. CONTRACTOR IS RESPONSIBLE FOR MEANS & METHODS INCLUDING ESTABLISHING AND MAINTAINING A SAFE OSHA COMPLIANT WORK ENVIRONMENT.
8. CONTRACTOR SHALL ARRANGE WITH THE UTILITY COMPANIES FOR THE DISCONNECTION OF SERVICES BEFORE STARTING DEMOLITION WORK AS REQUIRED.
9. PREVENT ACCESS OF UNAUTHORIZED PERSONS TO PARTLY DEMOLISHED STRUCTURES. PROVIDE BARRICADES OR RIBBONED OFF ZONES.
10. ITEMS FOR REUSE SHALL BE STORED BY CONTRACTOR ON SITE IN OWNER'S BUILDING AT SPECIFIED LOCATION. ITEMS TO BE RE-USED ARE TO BE CLEANED, PATCHED, REFINISHED, PAINTED OR REPAIRED AS REQUIRED PRIOR TO INSTALLATION.
11. ITEMS NOT TO BE RETAINED BY OWNER SHALL BE DISPOSED OF BY THE CONTRACTOR AT THE CONTRACTOR'S EXPENSE.
12. EXISTING ASPHALT, TREES, SPRINKLER HEADS, AND MISCELLANEOUS ITEMS THAT CONFLICT W/ PROPOSED CONSTRUCTION SHALL BE COORDINATED BY GENERAL CONTRACTOR FOR REMOVAL AND / OR RELOCATION PRIOR TO COMMENCEMENT OF WORK.
13. CONTRACTOR IS RESPONSIBLE FOR LEGALLY DISPOSING OF ALL MATERIALS AND ASSOCIATED COST OF INTERIM STORAGE FACILITIES (DUMPSTER).
14. PRIOR TO COMMENCEMENT OF DEMOLITION WORK CONTRACTOR SHALL INVESTIGATE EXISTING LOAD BEARING WALL CONDITIONS. IF LOAD BEARING WALLS ARE ENCOUNTERED AND NEED ALTERATIONS DUE TO NEW FLOOR PLAN LAYOUT THE STRUCTURE SHALL BE SHORED, BRACED AND SUPPORTED AS NEEDED TO MAINTAIN STRUCTURAL INTEGRITY DURING STRUCTURE MODIFICATIONS.
15. AFTER SCHEDULED DEMOLITION OF WALLS, FLOORS, CEILINGS CONTRACTOR SHALL PATCH WALLS, FLOORS, ROOFS W/ MATERIALS TO MATCH ADJACENT WALL, FLOOR, ROOF MATERIAL AS NEEDED FOR THE PROPER APPLICATION OF NEW FINISHES. PROVIDE FLUSH CONTINUOUS WALL, FLOOR, ROOF FINISHES.
16. POWER RECEPTACLES AND COMMUNICATION SYSTEM AND RELATED WIRING THAT CONFLICT W/ SCHEDULED CONSTRUCTION SHALL BE REMOVED.
17. H.V.A.C. GRILLES AND RELATED DUCTS AND HARDWARE THAT CONFLICT W/ SCHEDULED CONSTRUCTION SHALL BE REMOVED.
18. ACCESS TO PLUMBING LINES LOCATED ABOVE FLOOR AREAS SHALL BE COORDINATED WITH OWNER AS NEEDED. PLUMBING LINES SHALL BE CAPPED OR REMOVED AS REQUIRED FOR SCHEDULED CONSTRUCTION. ALL NEW FINISHES SHALL BE PATCHED AND REFINISHED AS NEEDED TO PROVIDE FLUSH, SMOOTH AND COMPATIBLE FINISHES TO ADJACENT AREAS.
19. REMOVE ALL CEILING ASSEMBLIES INCLUDING SUSPENSION SYSTEMS, HARDWARE, AND ALL RELATED ITEMS, AS REQ'D.
20. REMOVE EXISTING SUBSTRATES WHICH ARE DAMAGED OR NOT ACCEPTABLE FOR THE APPLICATION OF SCHEDULED NEW FINISHES.
21. ALL EXISTING PIPING PENETRATIONS THRU CONCRETE SLAB MUST BE CAPPED A MINIMUM OF 3" BELOW SLAB. EXISTING CONCRETE SLABS AND EDGES MUST BE LEFT SMOOTH.

**DEMOLITION SCHEDULE**

- |    |   |
|----|---|
| 1  | REMOVE EXISTING DOOR AND FRAME.   |
| 2  | REMOVE EXISTING WINDOW, FRAME, SILL AND ALL ATTACHMENTS                   |
| 3  | REMOVE EXISTING WALL (OR PORTION AS INDICATED)                            |
| 4  | NOT USED ON THIS SHEET  |
| 5  | NOT USED ON THIS SHEET  |
| 6  | NOT USED ON THIS SHEET  |
| 7  | NOT USED ON THIS SHEET  |
| 8  | REMOVE EXISTING WOODEN RAMP AND CONCRETE STAIRS BELOW, ALSO WOODEN STAIRS |
| 9  | REMOVE EXISTING CONCRETE RAMP   |
| 10 | NOT USED ON THIS SHEET  |
| 11 | NOT USED ON THIS SHEET  |
| 12 | NOT USED ON THIS SHEET  |
| 13 | NOT USED ON THIS SHEET  |
| 14 | REMOVE EXISTING CEILING, WOOD MEMBERS AND ROOF MATERIAL                   |
| 15 | NOT USED ON THIS SHEET  |
| 16 | NOT USED ON THIS SHEET  |
| 17 | NOT USED ON THIS SHEET  |
| 18 | NOT USED ON THIS SHEET  |
| 19 | REMOVE EXISTING WALL LOUVERS  |

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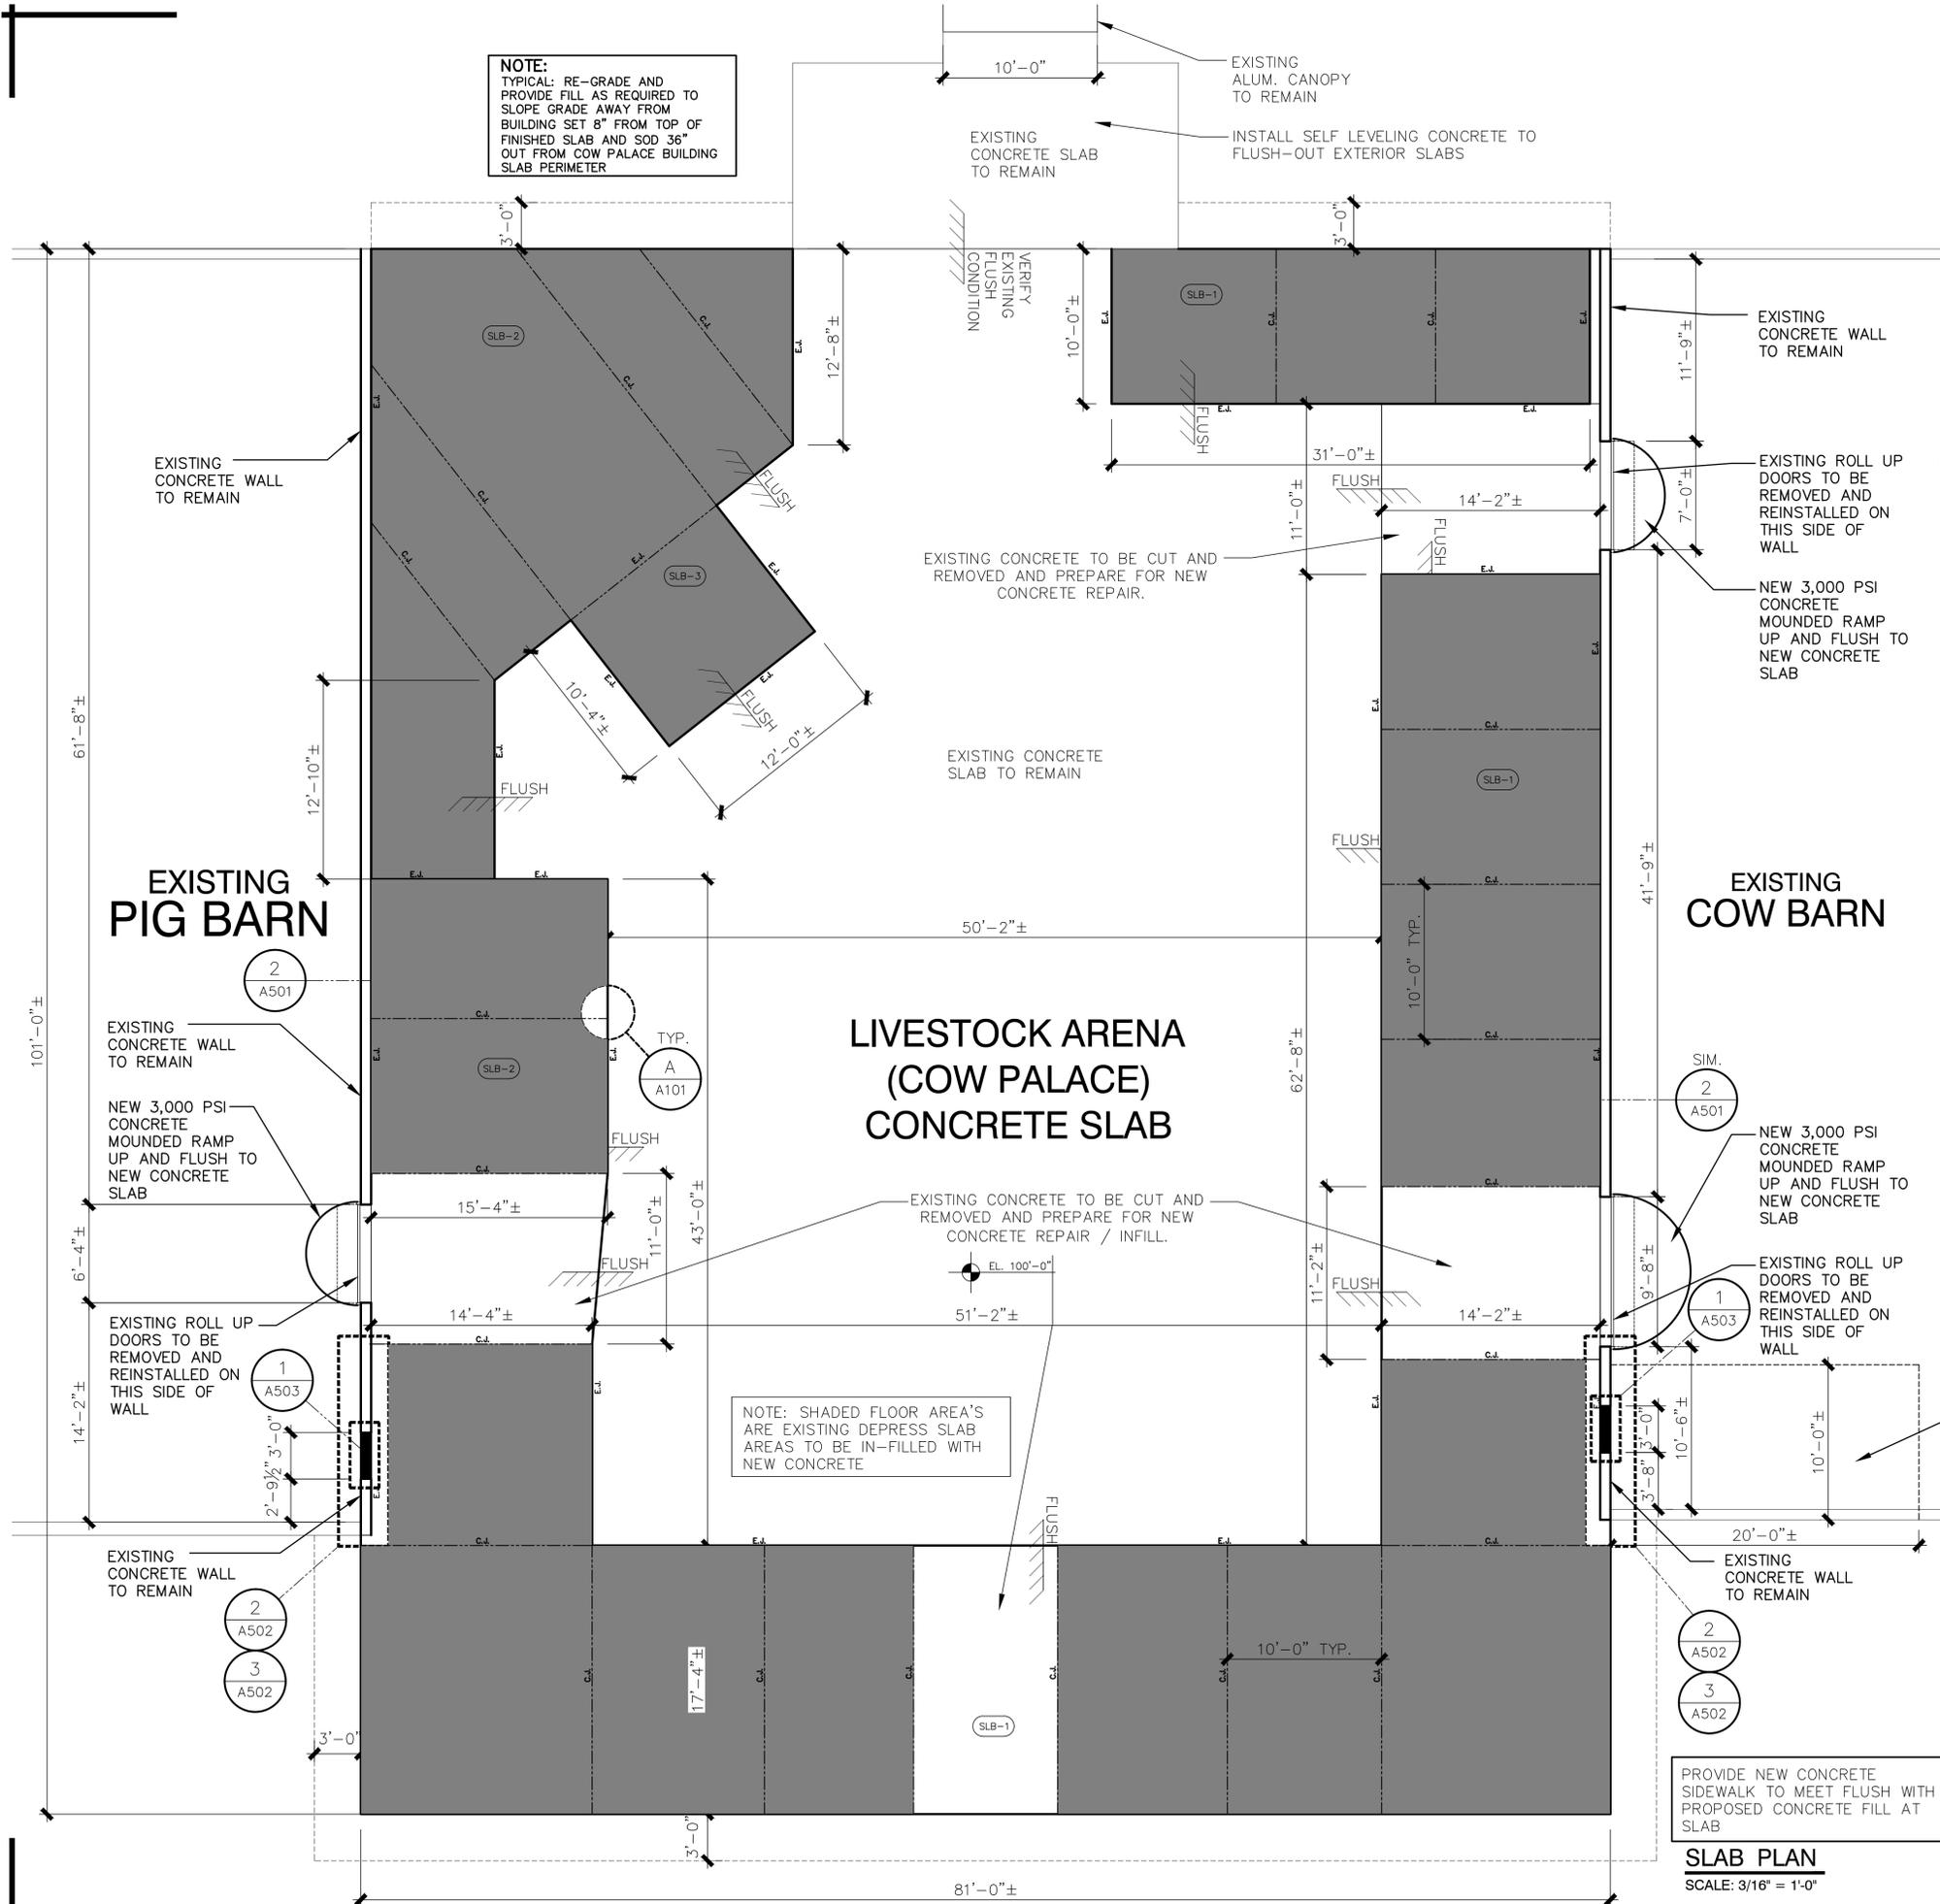
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 A DEMOLITION / CONSTRUCTION PLAN FOR:  
**SUMNER COUNTY LIVESTOCK ARENA (COW PALACE)**  
**7620 STATE ROAD 471**  
**BUSHNELL, FLORIDA 33513**

drawn ASI	project no. 1251
checked ASI	date 11-20-12
	sheet no. D101

100%  
CONSTRUCTION  
DRAWINGS

**NOTE:**  
TYPICAL: RE-GRADE AND PROVIDE FILL AS REQUIRED TO SLOPE GRADE AWAY FROM FINISHED SLAB AND SOD 36" OUT FROM COW PALACE BUILDING SLAB PERIMETER



**GENERAL NOTES**

1. PROVIDE 3,000 PSI CONC. MIN. UNLESS NOTED OTHERWISE
2. ALL EXTERIOR SLABS TO RECEIVE A BROOM FINISH IN DIRECTION OF SLOPE.
3. SAW-CUT CONTROL JOINTS AND EXPANSION JOINTS SHALL BE LOCATED AS SHOWN. THE GENERAL CONTRACTOR CAN INSTALL ADDITIONAL JOINTS IF REQUIRED, TO CONTROL CRACKING OF THE SLAB AND TO ENSURE PROPER SLAB CONSTRUCTION, FLATNESS, LEVELNESS AND DIFFERENTIAL SETTLEMENT.
4. CONTRACTOR TO VERIFY ALL CURRENT SITE CONDITIONS WITH SITE DOCUMENTS BY OTHERS AS WELL AS FINISHED FLOOR REQUIREMENTS AND CUT AND FILL OF SITE AS TO PROVIDE A STABLE AND SECURE HIGH AND DRY RESIDENCE.

**MINIMUM REQUIRED LAP SPLICES FOR REINFORCING RODS (GRADE 60 STEEL)**

ROD DIA.	LAP SPLICE	ROD DIA.	LAP SPLICE	ROD DIA.	LAP SPLICE
No.3	18"	No.6	36"	No.9	80"
No.4	24"	No.7	42"	No.10	88"
No.5	30"	No.8	66"	No.11	96"




**SLAB PLAN LEGEND**

EL. 100'-0" INDICATES ASSUMED FINISH FLOOR ELEVATION

**SLB-1** 6"± - 3,000 PSI CONC. SLAB REINFORCED W/ 6x6 # 10/10 W/M OR COMMERCIAL FIBERMESH MIX OVER EXISTING CONCRETE. SLAB CLEANED AND FREE OF DUST AND DEBRIS. PROVIDE BONDING AGENT OVER DIRT COMPACT TO 95% TERMITE TREATED AND INSTALL 6 MIL VAPOR BARRIER. PROVIDE CLEAN EARTHEN FILL AS REQUIRED.

**SLB-2** 4"± - 3,000 PSI CONC. SLAB REINFORCED W/ 6x6 # 10/10 W/M OR COMMERCIAL FIBERMESH MIX OVER EXISTING CONCRETE. SLAB CLEANED AND FREE OF DUST AND DEBRIS. PROVIDE BONDING AGENT OVER DIRT COMPACT TO 95% TERMITE TREATED AND INSTALL 6 MIL VAPOR BARRIER. PROVIDE CLEAN EARTHEN FILL AS REQUIRED.

**SLB-3** 2-1/2"± - 5,000 PSI WITH PEA GRAVEL CONC. HOT MIX, DESIGNED FOR THIN SLAB INSTALLATIONS. SLAB REINFORCED W/ 6x6 # 10/10 W/M OR COMMERCIAL FIBERMESH MIX OVER EXISTING CONCRETE. SLAB CLEANED AND FREE OF DUST AND DEBRIS. PROVIDE BONDING AGENT OVER DIRT COMPACT TO 95% TERMITE TREATED AND INSTALL 6 MIL VAPOR BARRIER. PROVIDE CLEAN EARTHEN FILL AS REQUIRED.

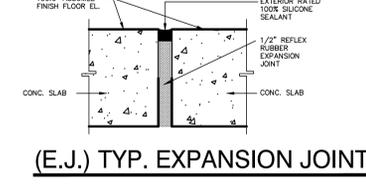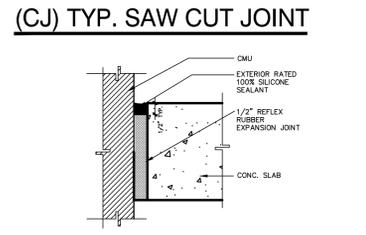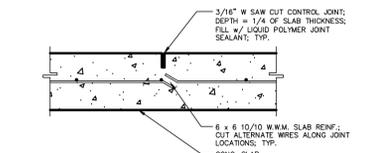

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A DEMOLITION / CONSTRUCTION PLAN FOR:  
**SUMNER COUNTY LIVESTOCK ARENA (COW PALACE)**  
7620 STATE ROAD 471  
BUSHNELL, FLORIDA 33513

drawn project no.  
ASI 1251

checked date  
ASI 11-20-12

sheet no.  
A101

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**SLAB PLAN**  
SCALE: 3/16" = 1'-0"

PROVIDE NEW CONCRETE SIDEWALK TO MEET FLUSH WITH PROPOSED CONCRETE FILL AT SLAB

2 A502  
3 A502

1 A503

2 A501

2 A501

1 A503

2 A502

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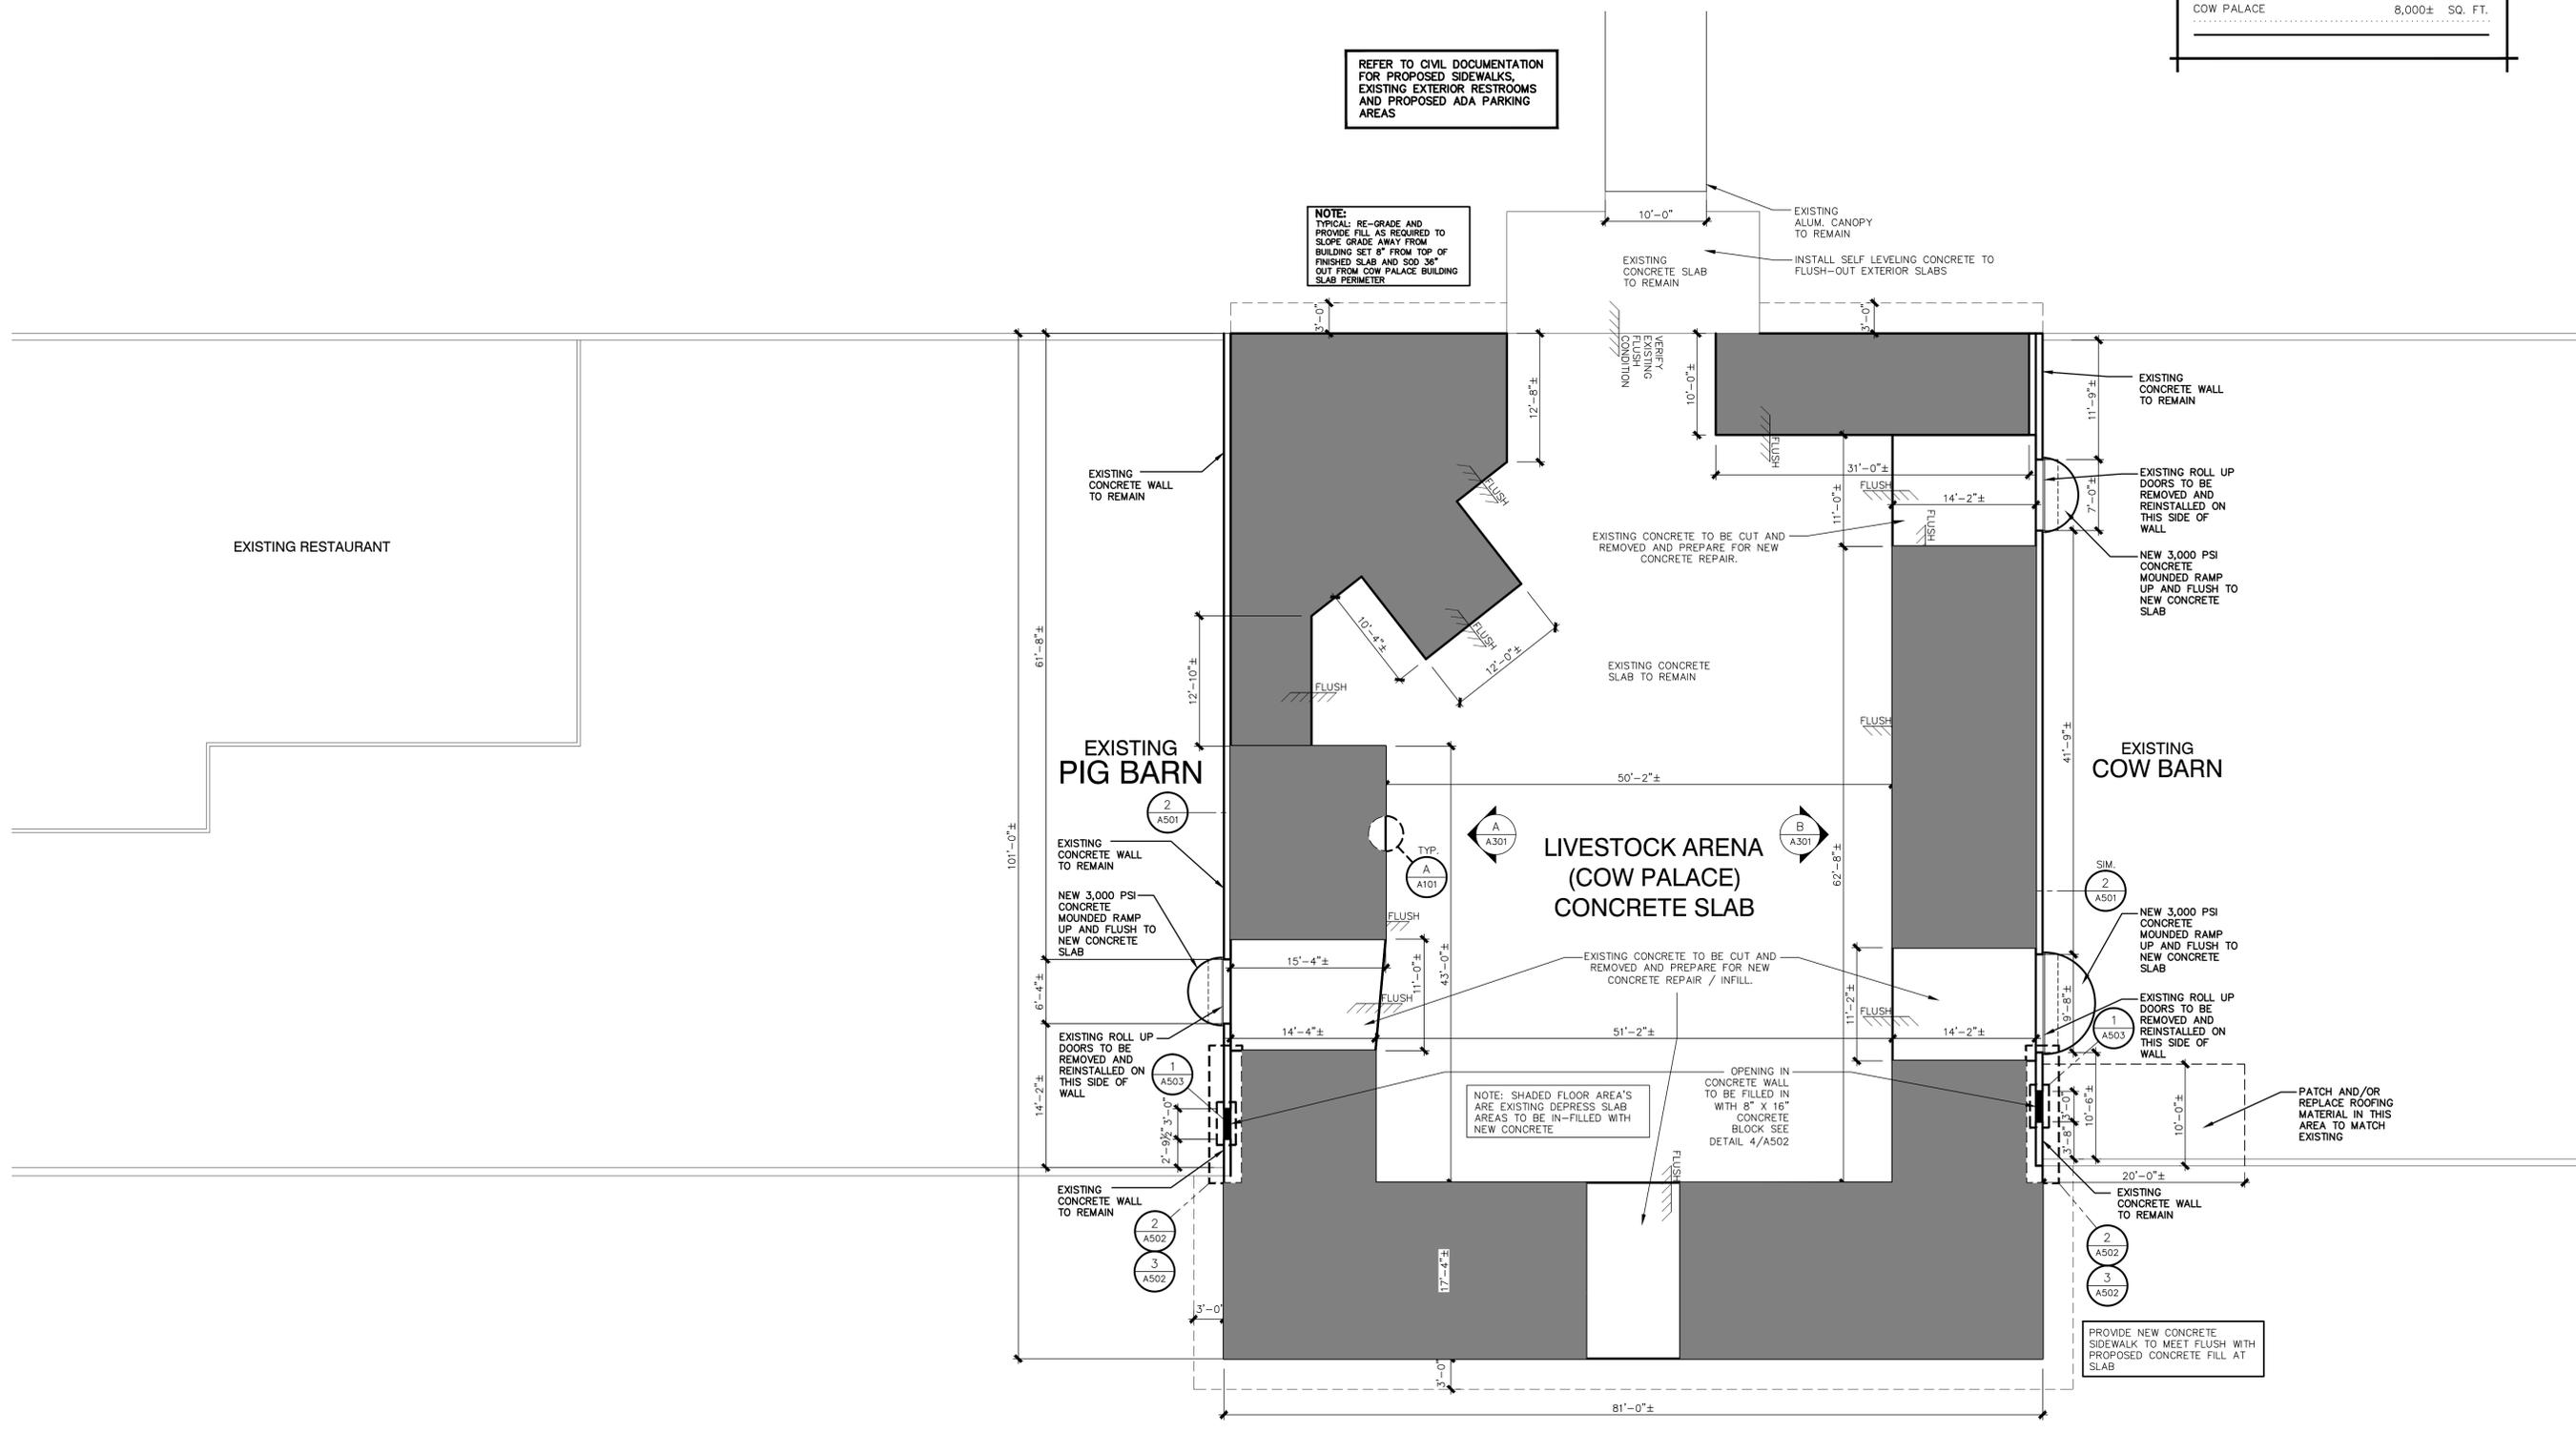
SQ. FT. DATA	
COW PALACE	8,000± SQ. FT.

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WALL TYPE LEGEND	GENERAL NOTES
<p>■ NEW EXTERIOR CMU WALL</p>	<p>1. ALL WORK SHALL BE EXECUTED IN ACCORDANCE WITH ALL GOVERNING NATIONAL, STATE AND LOCAL CODES AND REGULATIONS.</p> <p>2. FOR SPECIFIC SITE PLAN INFORMATION REFER TO CIVIL DRAWINGS PREPARED BY OTHERS.</p> <p>3. ALL BUILDING ELEMENTS SHALL BE INSTALLED STRAIGHT, LEVEL, PLUMB AND SQUARE. ALL GYPSUM WALL BOARD SHALL BE INSTALLED VERTICALLY W/ NO HORIZONTAL JOINTS.</p> <p>4. DUE TO MATERIAL TOLERANCES THE GENERAL CONTRACTOR MUST VERIFY ALL DIMENSIONS WITH ACTUAL CONDITIONS ON THE SITE AND REPORT ANY DIFFERENCES TO THE ARCHITECT FOR INTERPRETATION AND RESOLUTION PRIOR TO COMMENCEMENT OF WORK.</p>

PROPOSED FLOOR PLAN - NOTES AND TAGS  
SCALE: 1/8" = 1'-0"


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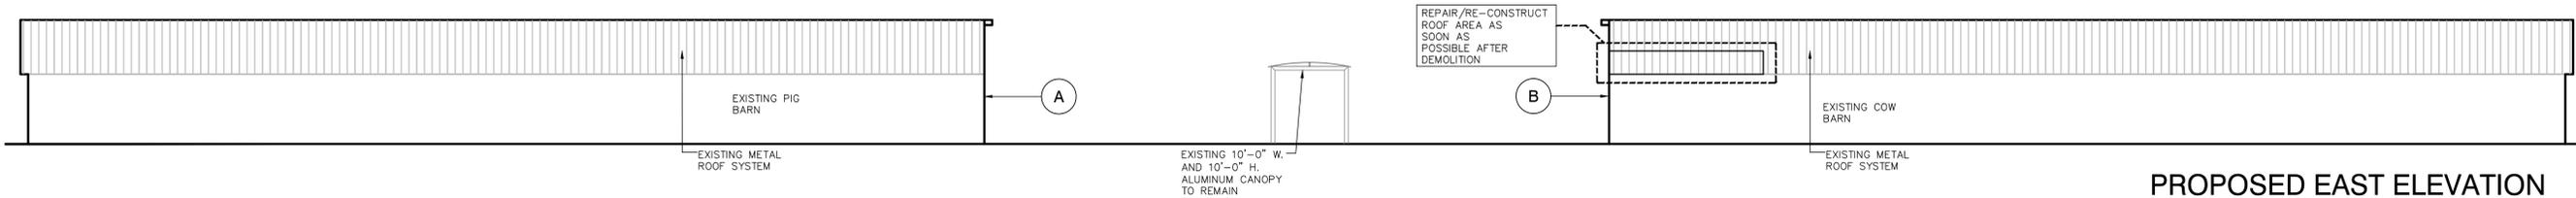
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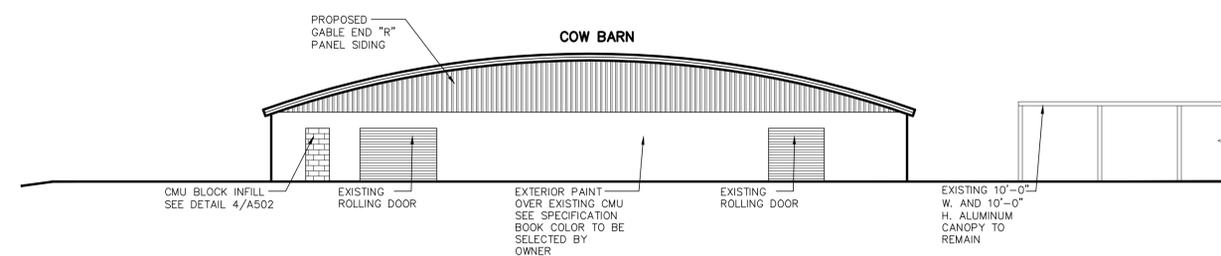





**PROPOSED WEST ELEVATION**  
SCALE: 3/32" = 1'-0"



**PROPOSED EAST ELEVATION**  
SCALE: 3/32" = 1'-0"

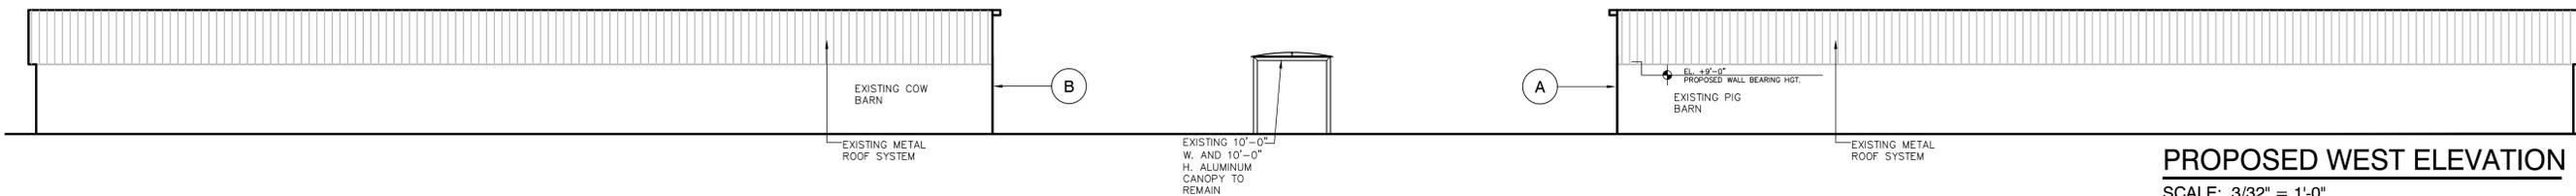

**PROPOSED B ELEVATION**  
SCALE: 3/32" = 1'-0"

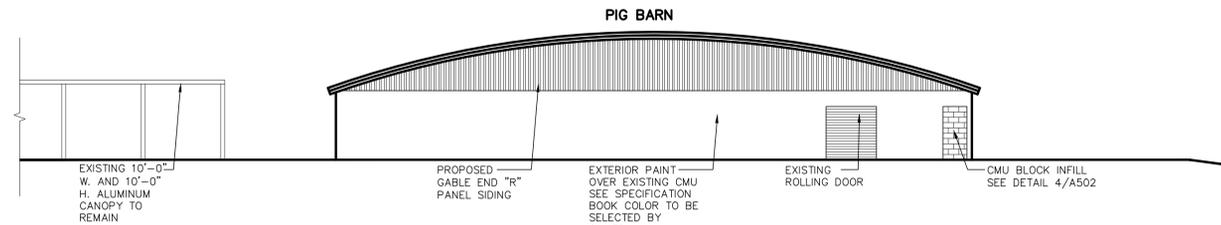

**PROPOSED A ELEVATION**  
SCALE: 3/32" = 1'-0"

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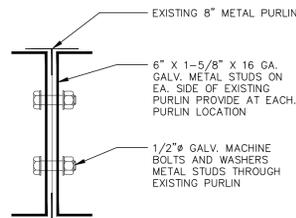
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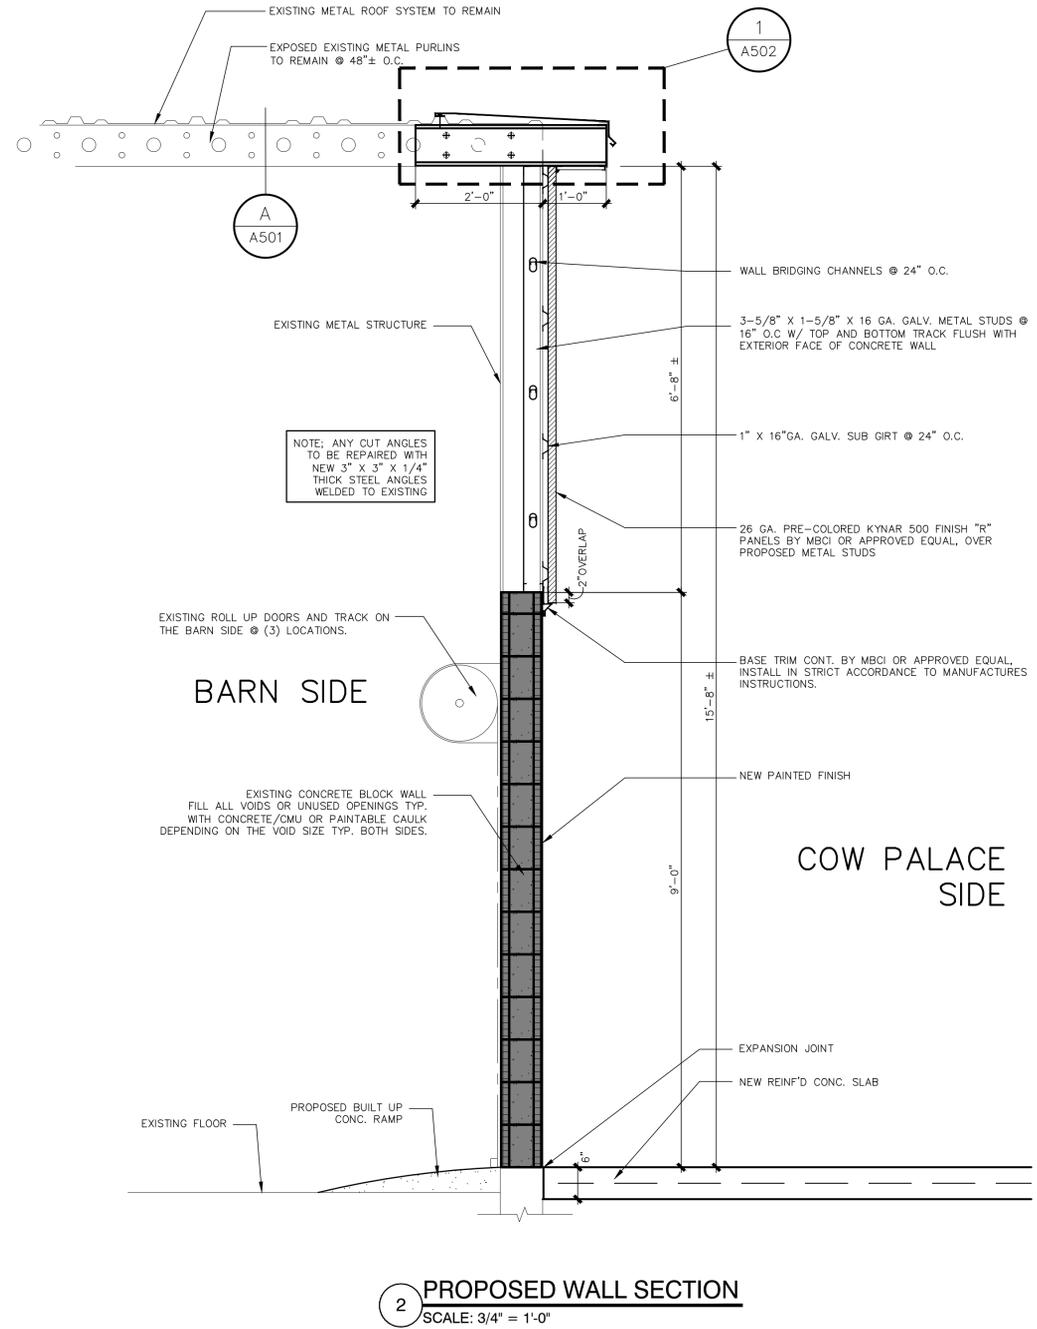
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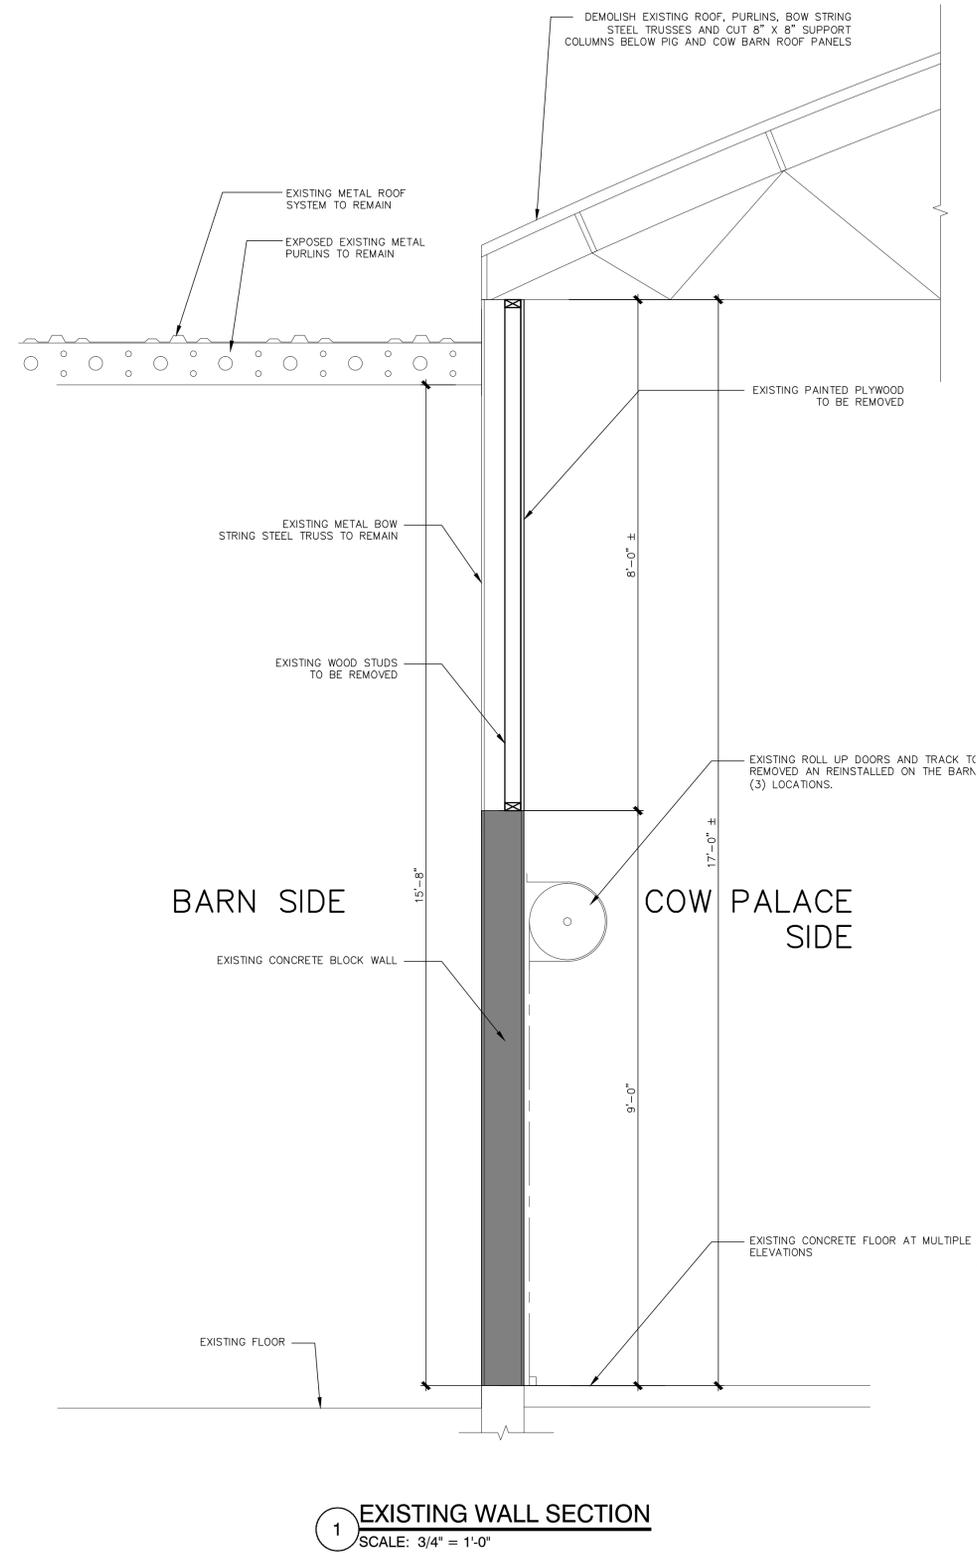
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**A EXISTING PURLIN DETAIL**  
SCALE: 3" = 1'-0"



**2 PROPOSED WALL SECTION**  
SCALE: 3/4" = 1'-0"



**1 EXISTING WALL SECTION**  
SCALE: 3/4" = 1'-0"

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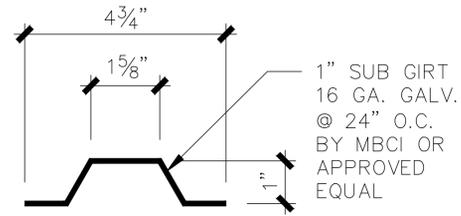
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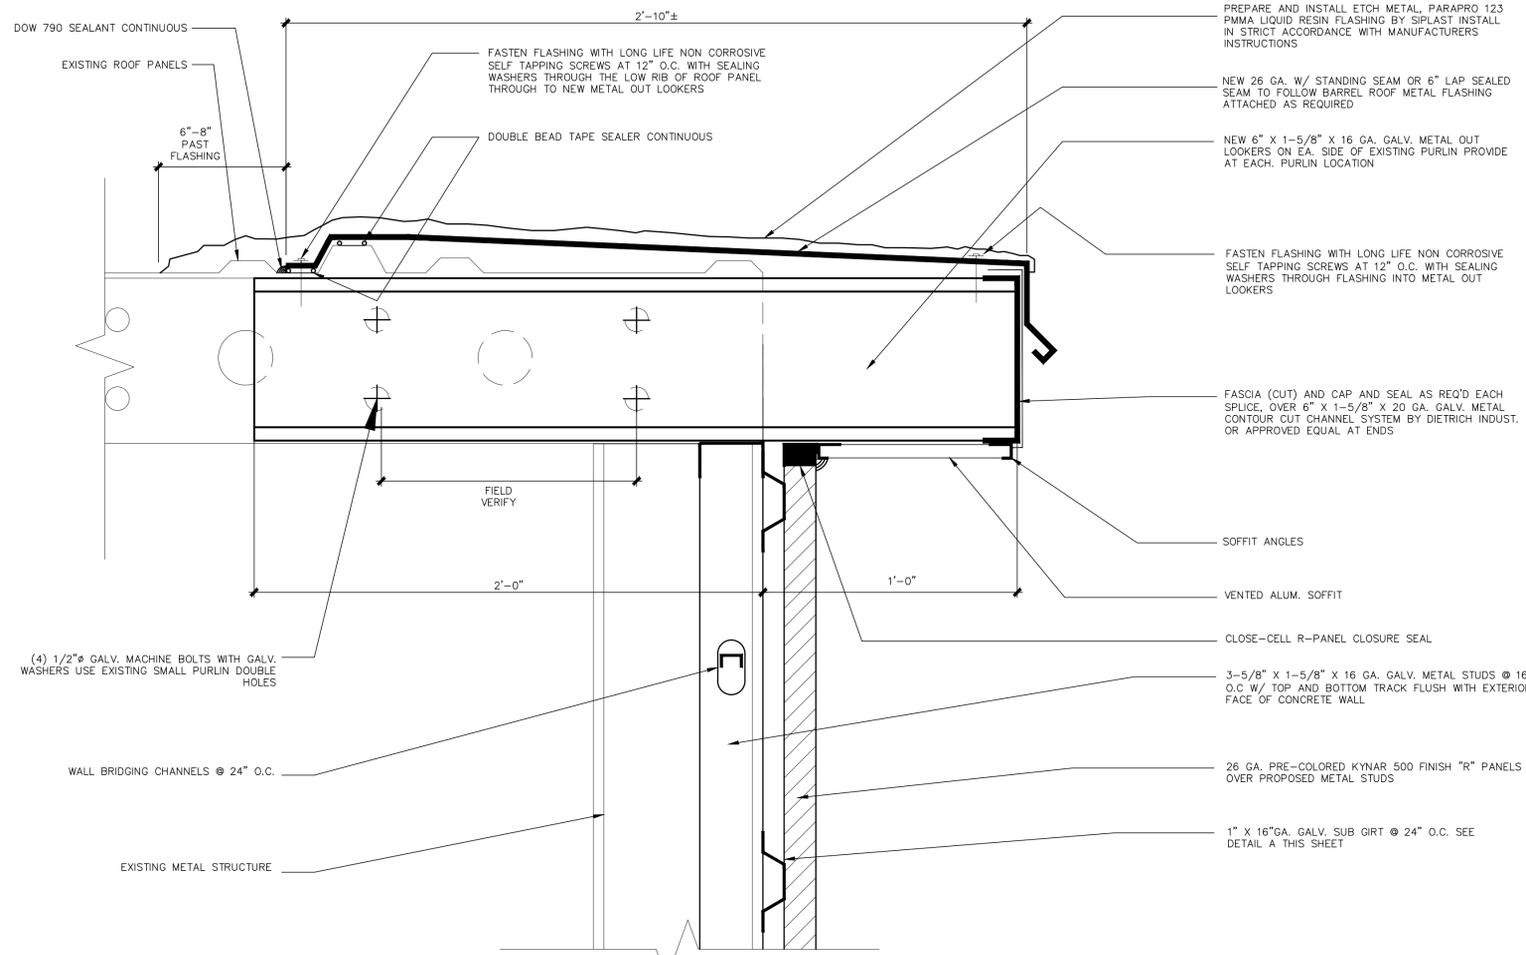
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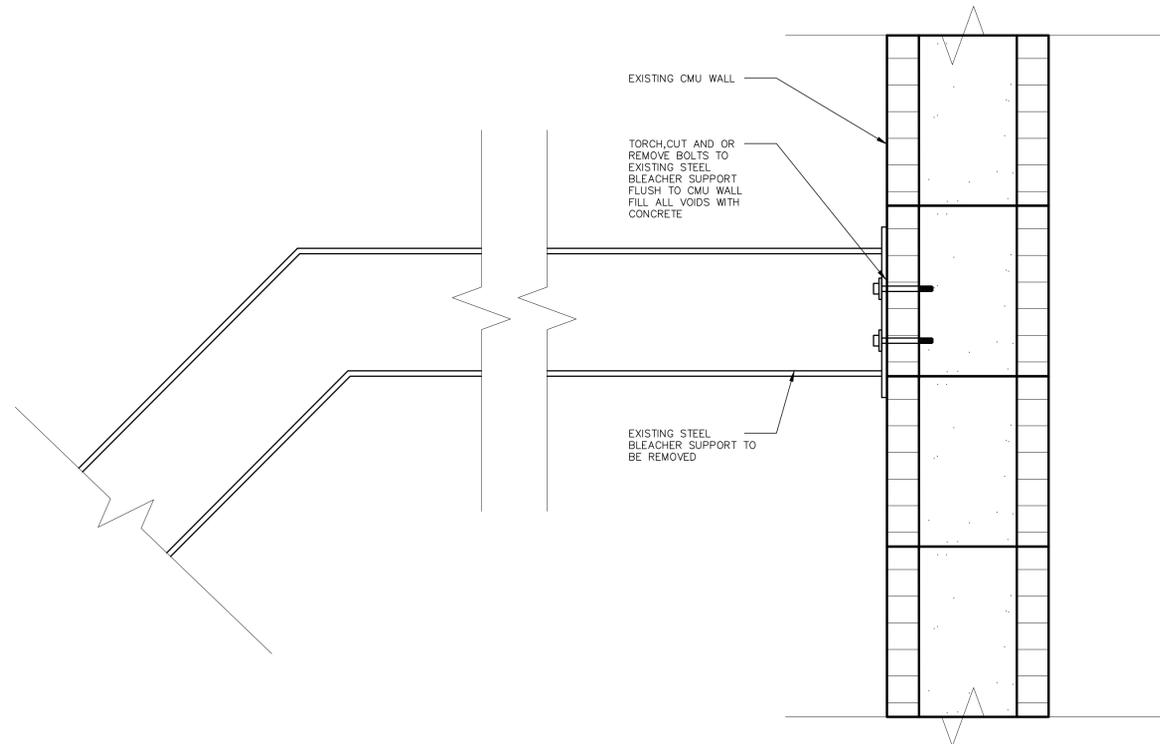
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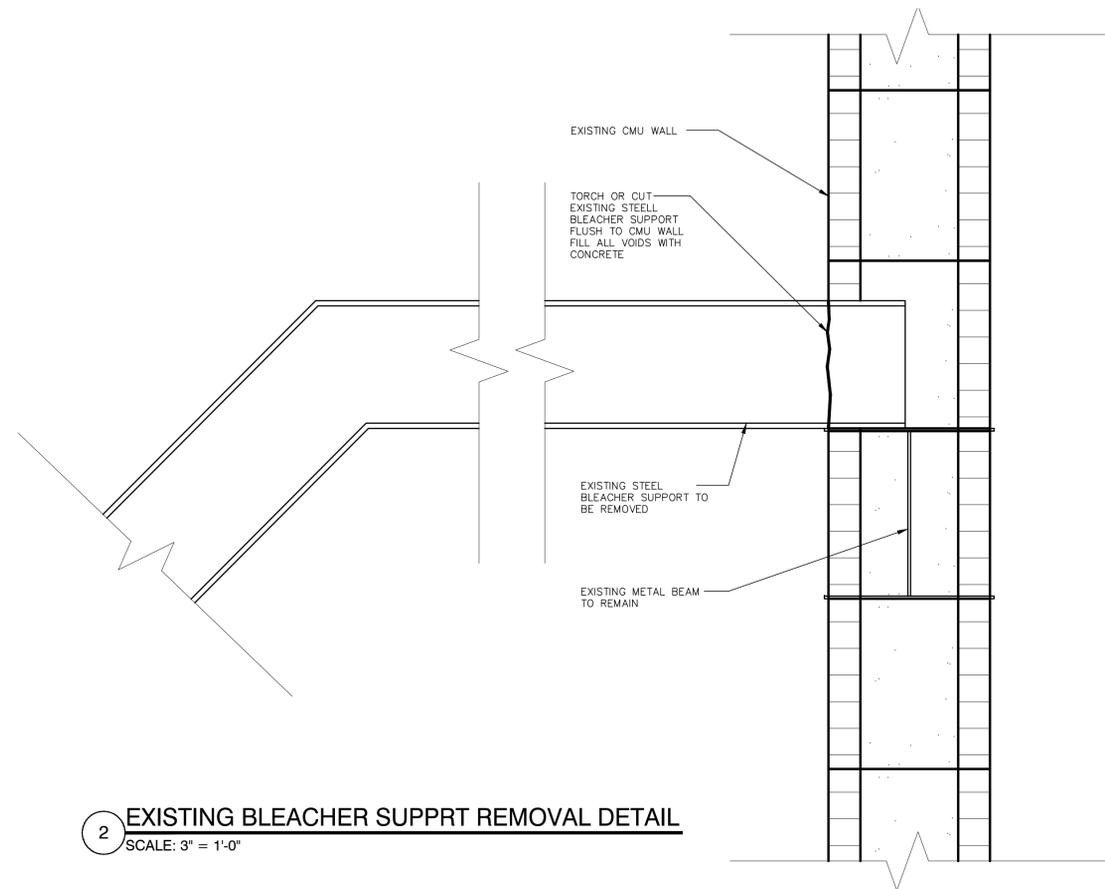
**A SUB-GRIT DETAIL**  
SCALE: 6" = 1'-0"



**1 GABLE END ROOF ENCLOSURE DETAIL**  
SCALE: 3" = 1'-0"




**3 EXISTING BLEACHER SUPPRT REMOVAL DETAIL**  
SCALE: 3" = 1'-0"



**2 EXISTING BLEACHER SUPPRT REMOVAL DETAIL**  
SCALE: 3" = 1'-0"

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<p>drawn ASI</p> <p>checked ASI</p>	<p>project no. 1251</p> <p>date 11-20-12</p> <p>sheet no. A502</p>
<p>100% CONSTRUCTION DRAWINGS</p>	

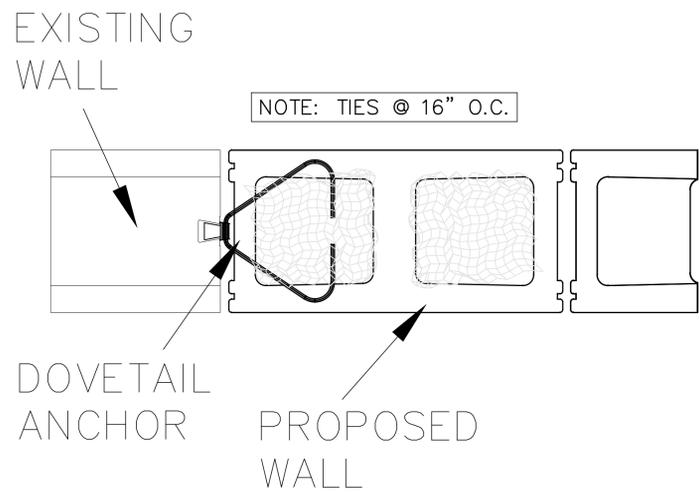

**A DOVETAIL TRIANGULAR ANCHOR DETAIL**  
SCALE: NTS




**Heckmann Building Products Inc.**  
1501 N. 31<sup>st</sup> Avenue  
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**SUBMITTAL SHEET:  
#103 DOVETAIL TRIANGULAR ANCHOR**

Used for attaching brick veneer to an existing concrete wall that contains standard 1" deep x 1" wide dovetail slot with a 5/8" throat at the face of concrete. (See Heckmann #100 Dovetail Slot sheet for Anchor Slot Specifications).


Standard Sizes: 12 gage dovetail clip attached to a 3/16" diameter wire triangle tie in the following lengths: 2", 4", 5", 6", 8", 9", and 11". Available in Mill Galvanized, Hotdip Galvanized After Fabrication, and Stainless Steel.

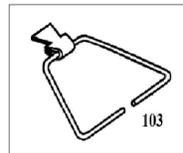

**Stainless Steel:**  
Sheet metal anchors and ties: ASTM A 167 AISI Type 304.  
Plate and bent bar anchors: ASTM A 666 AISI Type 304.  
Wire ties and anchors: ASTM A 580 AISI Type 304.  
**Hotdip Galvanized:**  
ASTM A 153 Class B-2: (1.50 oz/ft<sup>2</sup>)(0.46kg/m<sup>2</sup>)  
**Mill Galvanized:**  
Sheet metal anchors and ties: ASTM A 653 G60  
Wire: ASTM A 641 (0.1 oz/ft<sup>2</sup>)  
**Plain Steel:**  
Sheet Metal anchors and ties: ASTM A 569, ASTM A 366  
Plates, bars, and shapes: ASTM A 113, ASTM A 36.

**Test Data**

TEST RESULTS	TENSION	COMPRESSION		SHEAR
		1" Cavity (25.4mm)	3" Cavity (76.2mm)	
R.E.E.L. Loads	327 lbs	509 lbs	282 lbs	138 lbs
deflection	.039 in. (.9906mm)	.072 in. (1.828mm)	.044 in. (1.117mm)	.039 in. (.9906mm)
R.E.M. Loads	713 lbs	560 lbs	386 lbs	347 lbs
deflection	1.79 in. (4.546mm)	.090 in. (2.286mm)	.140 in. (3.556mm)	.361 in. (9.169mm)
Peak Loads	751 lbs	616 lbs	701 lbs	371 lbs
deflection	.286 in. (7.264mm)	.140 in. (3.556mm)	.272 in. (6.908mm)	.452 in. (11.48mm)

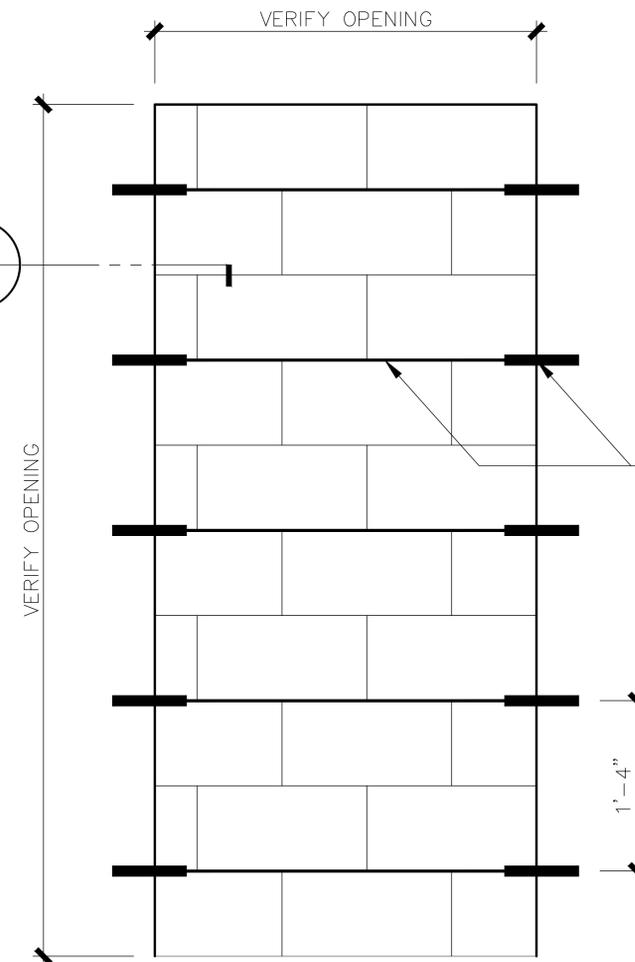

**1 WALL ENCLOSURE DETAIL**  
SCALE: 1-1/2" = 1'-0"

PROVIDE DOVETAIL TRIANGULAR ANCHOR SEE DETAIL THIS SHEET ALSO INSTALL DUR-O-LADDER TYPE MASONRY WALL REINFORCING @ 16" O.C. VERTICAL @ JOINTS, TYP.

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sheet no.  
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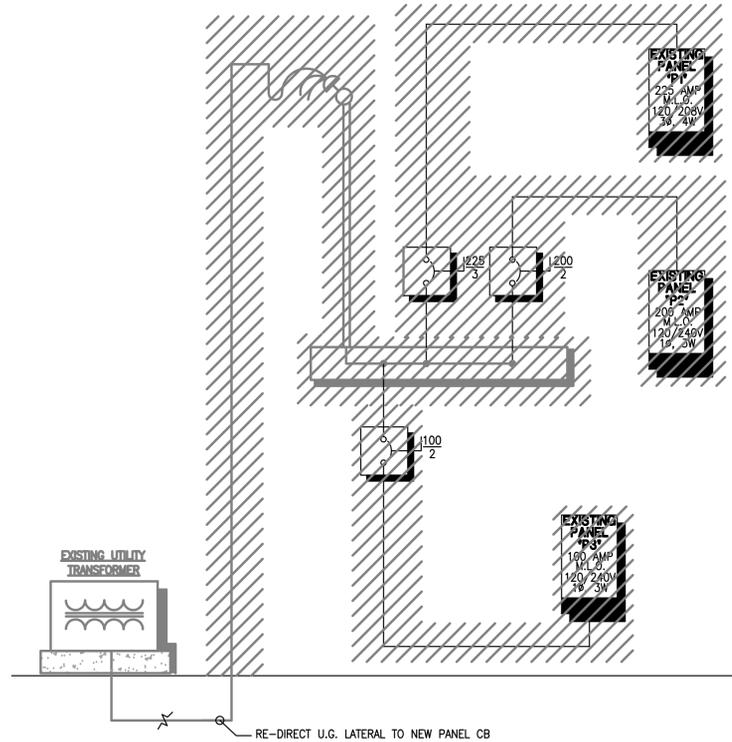
**TYPICAL MECHANICAL, PLUMBING & ELECTRICAL DEMOLITION NOTES:**

- A. THE CONTRACTOR SHALL VISIT AND CAREFULLY EXAMINE THOSE PORTIONS OF THE BUILDING AND SITE AFFECTED BY THIS WORK BEFORE SUBMITTING PROPOSAL SO AS TO BECOME FAMILIAR WITH EXISTING WORK. SUBMISSION OF A PROPOSAL WILL BE CONSTRUED AS EVIDENCE. THAT SUCH EXAMINATION HAS BEEN MADE AND LATER CLAIMS FOR LABOR, EQUIPMENT OR MATERIALS REQUIRED BECAUSE OF DIFFICULTIES ENCOUNTERED WILL NOT BE RECOGNIZED. IT IS TO BE UNDERSTOOD THAT UNFORESEEN CONDITIONS PROBABLY EXIST AND NEW WORK MAY NOT BE FIELD LOCATED EXACTLY AS SHOWN ON THE DRAWINGS. COOPERATION WITH OTHER TRADES IN EQUIPMENT ROUTING AS DETERMINED DURING CONSTRUCTION AND AS DIRECTED BY THE ARCHITECT/ENGINEER MAY BE NECESSARY AND IT IS INTENDED THAT SUCH DEVIATIONS SHALL BE CONSIDERED AS PART OF THIS CONTRACT. IT IS ALSO UNDERSTOOD THAT THE PLANS ARE NOT COMPLETELY TO SCALE. THIS CONTRACTOR IS TO FIELD VERIFY DIMENSIONS OF ALL EXISTING CONDITIONS, PRIOR TO BID AND INCLUDE ANY DEVIATIONS IN THE CONTRACT.
- B. ALL DEVICES AND EQUIPMENT NOT SHOWN AND IN AREAS OUTSIDE OF REMODELING SHALL REMAIN ACTIVE UNLESS OTHERWISE NOTED. INSTALL AS REQUIRED TO MAINTAIN CONTINUITY TO EXISTING DEVICES AND EQUIPMENT THAT ARE TO REMAIN.
- C. ALL EQUIPMENT AND MATERIAL REMOVED AND NOT REUSED SHALL BE TURNED OVER TO THE OWNER OR AT THE OWNERS REQUEST LEGALLY DISPOSED OF BY THE CONTRACTOR.
- D. ALL EXISTING EQUIPMENT IS NOT SHOWN. IT IS THE CONTRACTORS RESPONSIBILITY TO BECOME FAMILIAR WITH ALL EXISTING CONDITIONS PRIOR TO BID, AND INCLUDE THE REMOVAL OF ALL EQUIPMENT, CONDUIT, WIRE, ETC. THAT IS NOT BEING REUSED BACK TO ITS SOURCE.

**REFERENCE NOTES**

(SEE TYPICAL DEMOLITION NOTES)


- ① REMOVE UNDERGROUND SERVICE ENTRANCE LATERAL TO UTILITY POLE. COORDINATE WITH UTILITY FOR DISCONNECTION SCHEDULE.
- ② REMOVE EXISTING ELECTRICAL SERVICE ENTRANCE EQUIPMENT AND ALL CONDUIT, WIRING AND CONNECTIONS.
- ③ REMOVE ALL EXISTING ELECTRICAL, MECHANICAL AND PLUMBING EQUIPMENT, DEVICES AND WIRING FOR COW PALACE FACILITY. REFEED ALL DOWNSTREAM DEVICES TO REMAIN IN SERVICE.
- ④ REMOVE ALL EXISTING MECHANICAL EQUIPMENT, WIRING, PIPING, CONCRETE SLABS, SUPPORTS, DUCTWORK COMPLETELY BACK TO POINT OF ORIGIN.
- ⑤ REMOVE ALL HVAC EQUIPMENT SERVING THE ENTIRE FACILITY.
- ⑥ REMOVE ALL PLUMBING FOR THE ENTIRE FACILITY. RECONNECT ALL DOWNSTREAM DEVICES AND PLUMBING SYSTEMS TO REMAIN.
- ⑦ NEW COW BARN ELECTRICAL PANEL CB.
- ⑧ REDIRECT U.G. SERVICE ENTRANCE LATERAL TO COW BARN FOR NEW ELECTRICAL SERVICE. COORDINATE RECONNECTION WITH UTILITY COMPANY.
- ⑨ BACK FEED EXISTING COW BARN PANEL.
- ⑩ NEW W.P. GFCI DOUBLE DUPLEX OUTLET AT 36" A.F.F.
- ⑪ EXISTING COW PALACE ELECTRICAL SERVICE #1.
- ⑫ NEW 120 VOLT 250 WATT METAL HALIDE WALL PACK LIGHT FIXTURE. MOUNT FIXTURE AT 12'-0" A.F.G. TO TOP OF FIXTURE. FIXTURE SHALL BE LITHONIA #TWH-250M-M VOLT. SURFACE MOUNT ALL CONDUIT FROM REAR OF COW AND PIG BARN.
- ⑬ EXISTING COW PALACE SERVICE #2.



**DEMOLITION ELECTRICAL RISER DIAGRAM #1**  
NTS

NEW PANEL CB		RATING 400 AMP M.C.B.		LUG LOCATION TOP		A.I.C. 42K	
		SERVICE 120/208V, 3ø, 4W		MOUNTING SURFACE NEMA 3R		TYPE SQ. D NQDD OR EQUAL	
CKT. NO. SERVED	KVA	CKT. BKR.	BRANCH CIRCUIT			CKT. NO. SERVED	KVA
		POLE	TR	Ø	NEUT	GND	COND
1	4.00	2	100	2	2	6	1-1/2"
3	4.00	-	-	-	-	-	-
5	1.00	1	20	10	10	10	3/4"
7	1.00	1	20	10	10	10	3/4"
9	1.00	1	20	10	10	10	3/4"
11	1.00	1	20	10	10	10	3/4"
13	1.00	1	20	10	10	10	3/4"
15	1.00	1	20	10	10	10	3/4"
17	1.00	1	20	10	10	10	3/4"
19	1.00	1	20	10	10	10	3/4"
21		1	20				
23		1	20				
25		1	20				
27		1	20				
29		1	20				
31		1	20				
33		1	20				
35		1	20				
37		1	20				
39		1	20				
41		1	20				
EQUIPMENT SERVED				CONN. LOAD		LF	DF
LTG.				2.50		1.25	23.13
RECEPTACLES				8.00			8.00
EXISTING PANEL AT COW BARN				8.00			8.00
				TOTAL			39.13
				DESIGN LOAD (KVA)			42 CIRCUITS
							109 AMPS

- PROVIDE GRND BUS & NEUTRAL BUS
- PROVIDE TYPE WRITTEN DIRECTORY
- PROVIDE W.P. ENCLOSURE
- PROVIDE LOCK

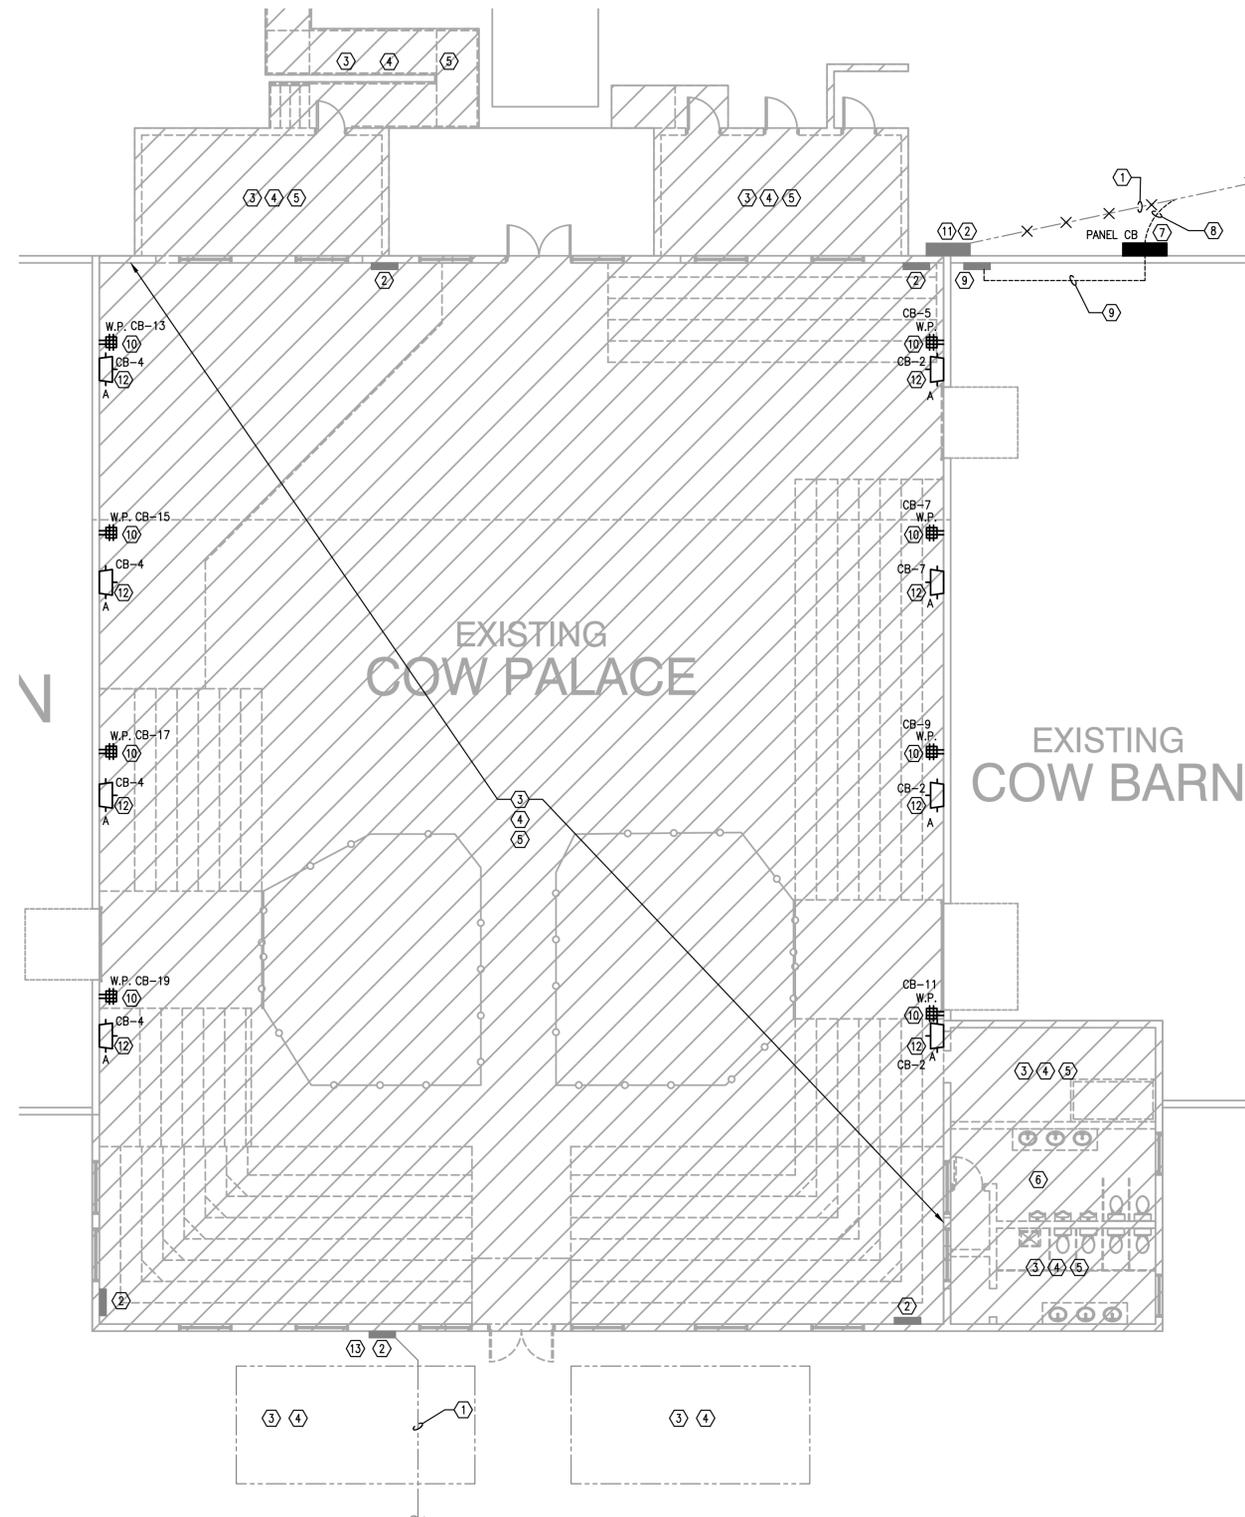

**MECHANICAL, PLUMBING & ELECTRICAL DEMOLITION AND NEW ELECTRICAL WORK PLAN**

SCALE: 1/8" = 1'-0"

revisions

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114 south magnolia avenue  
ocala, florida 34471  
p. (352) 620-0944 f. (352) 620-0996  
www.rispolisosa.com  
florida license aa0002485 rsa@rispolisosa.com

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A DEMOLITION PLAN FOR:  
**SUMTER COUNTY LIVESTOCK ARENA (COW PALACE)**  
7620 STATE ROAD 471  
BUSHNELL, FLORIDA 33513

drawn project no.  
MRB 1251  
checked date  
DFG 11-20-12  
sheet no.

**Ingenuity** engineers  
"Proactive Engineering Solutions"

4798 new broad street  
suite 300  
orlando, fl 32814  
407.398.6007 (p)  
407.398.6003 (f)

Brian S. Hessinger, PE  
C.A.# 26308  
PE No. 52660

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